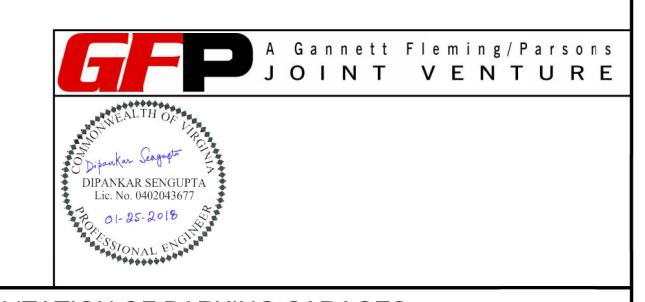
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DESIGNED	IX. SHAII	DATE			01/25/2018	0	FINAL SUBMITTAL		
DRAWN	A. PINKOWSKI	01/2018							
210	A. PINKOWSKI _	DATE							
CHECKED	R. SHAH	01/2018							
		DATE							

WASHINGTON METROPOLITAN AREA TRANSIT AUTHORITY

OFFICE OF THE CHIEF OPERATING OFFICER
IRPG - FIXED FACILITIES

APPROVED 01/25/2018

JOHN PURDY DATE


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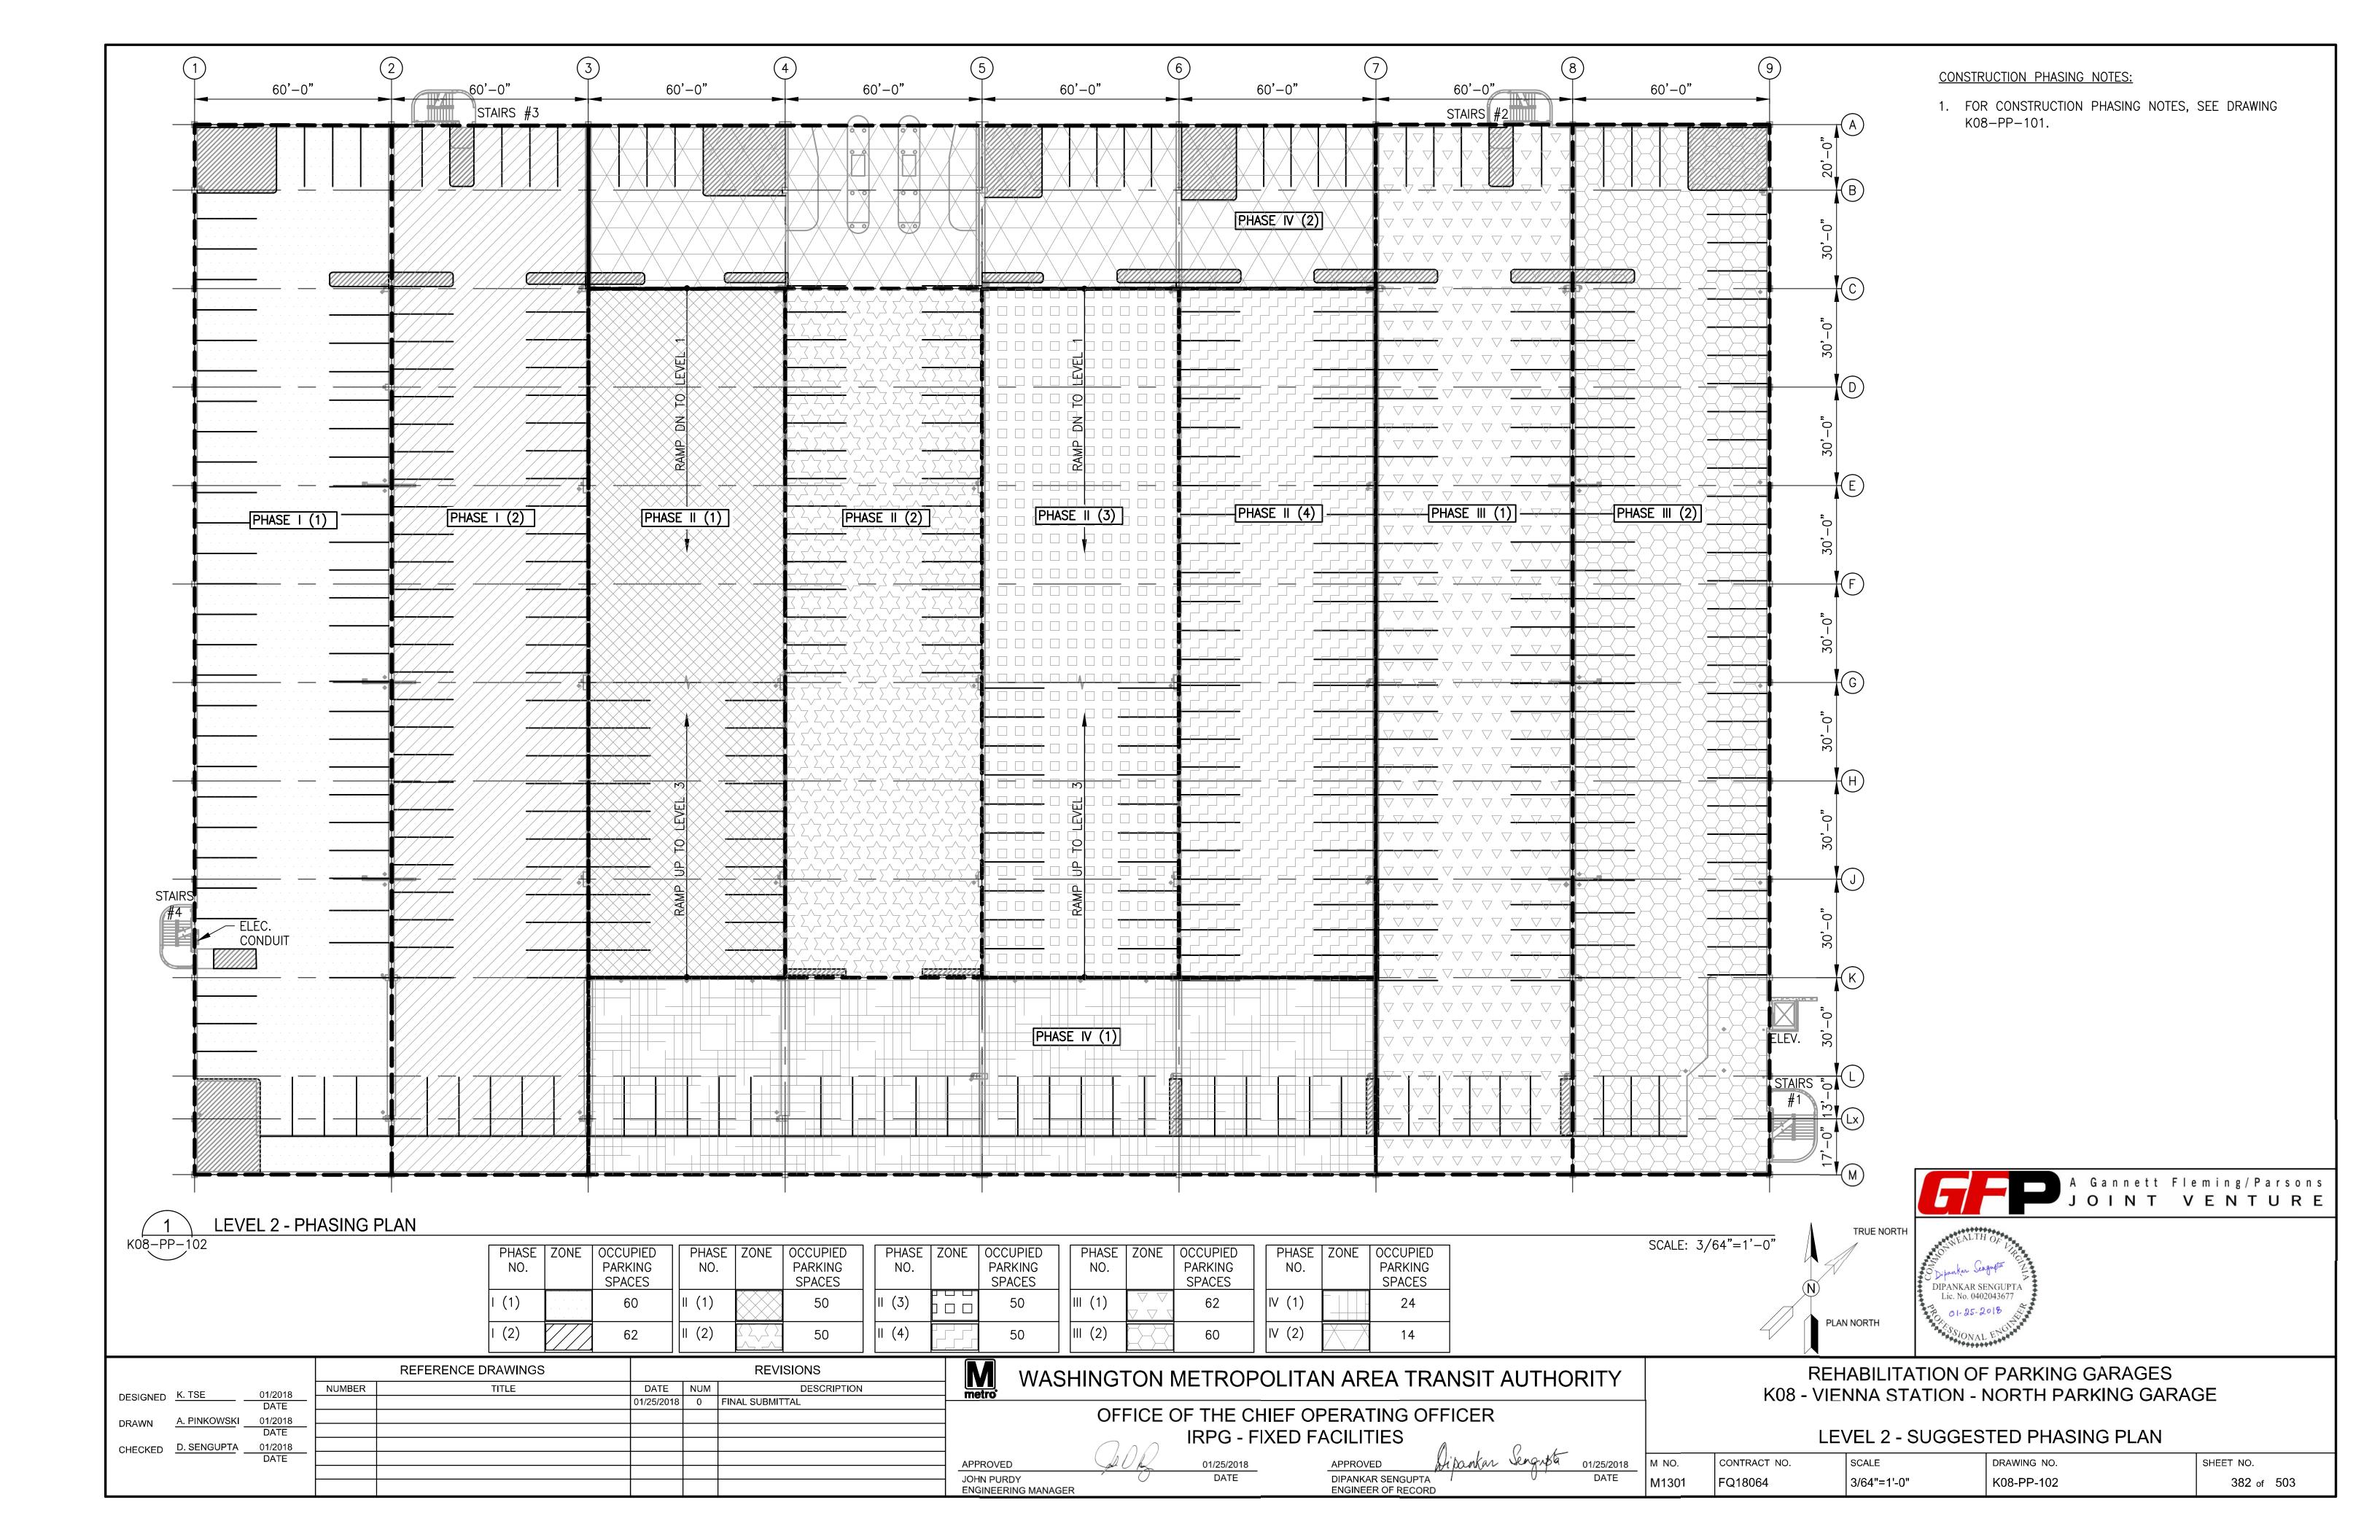
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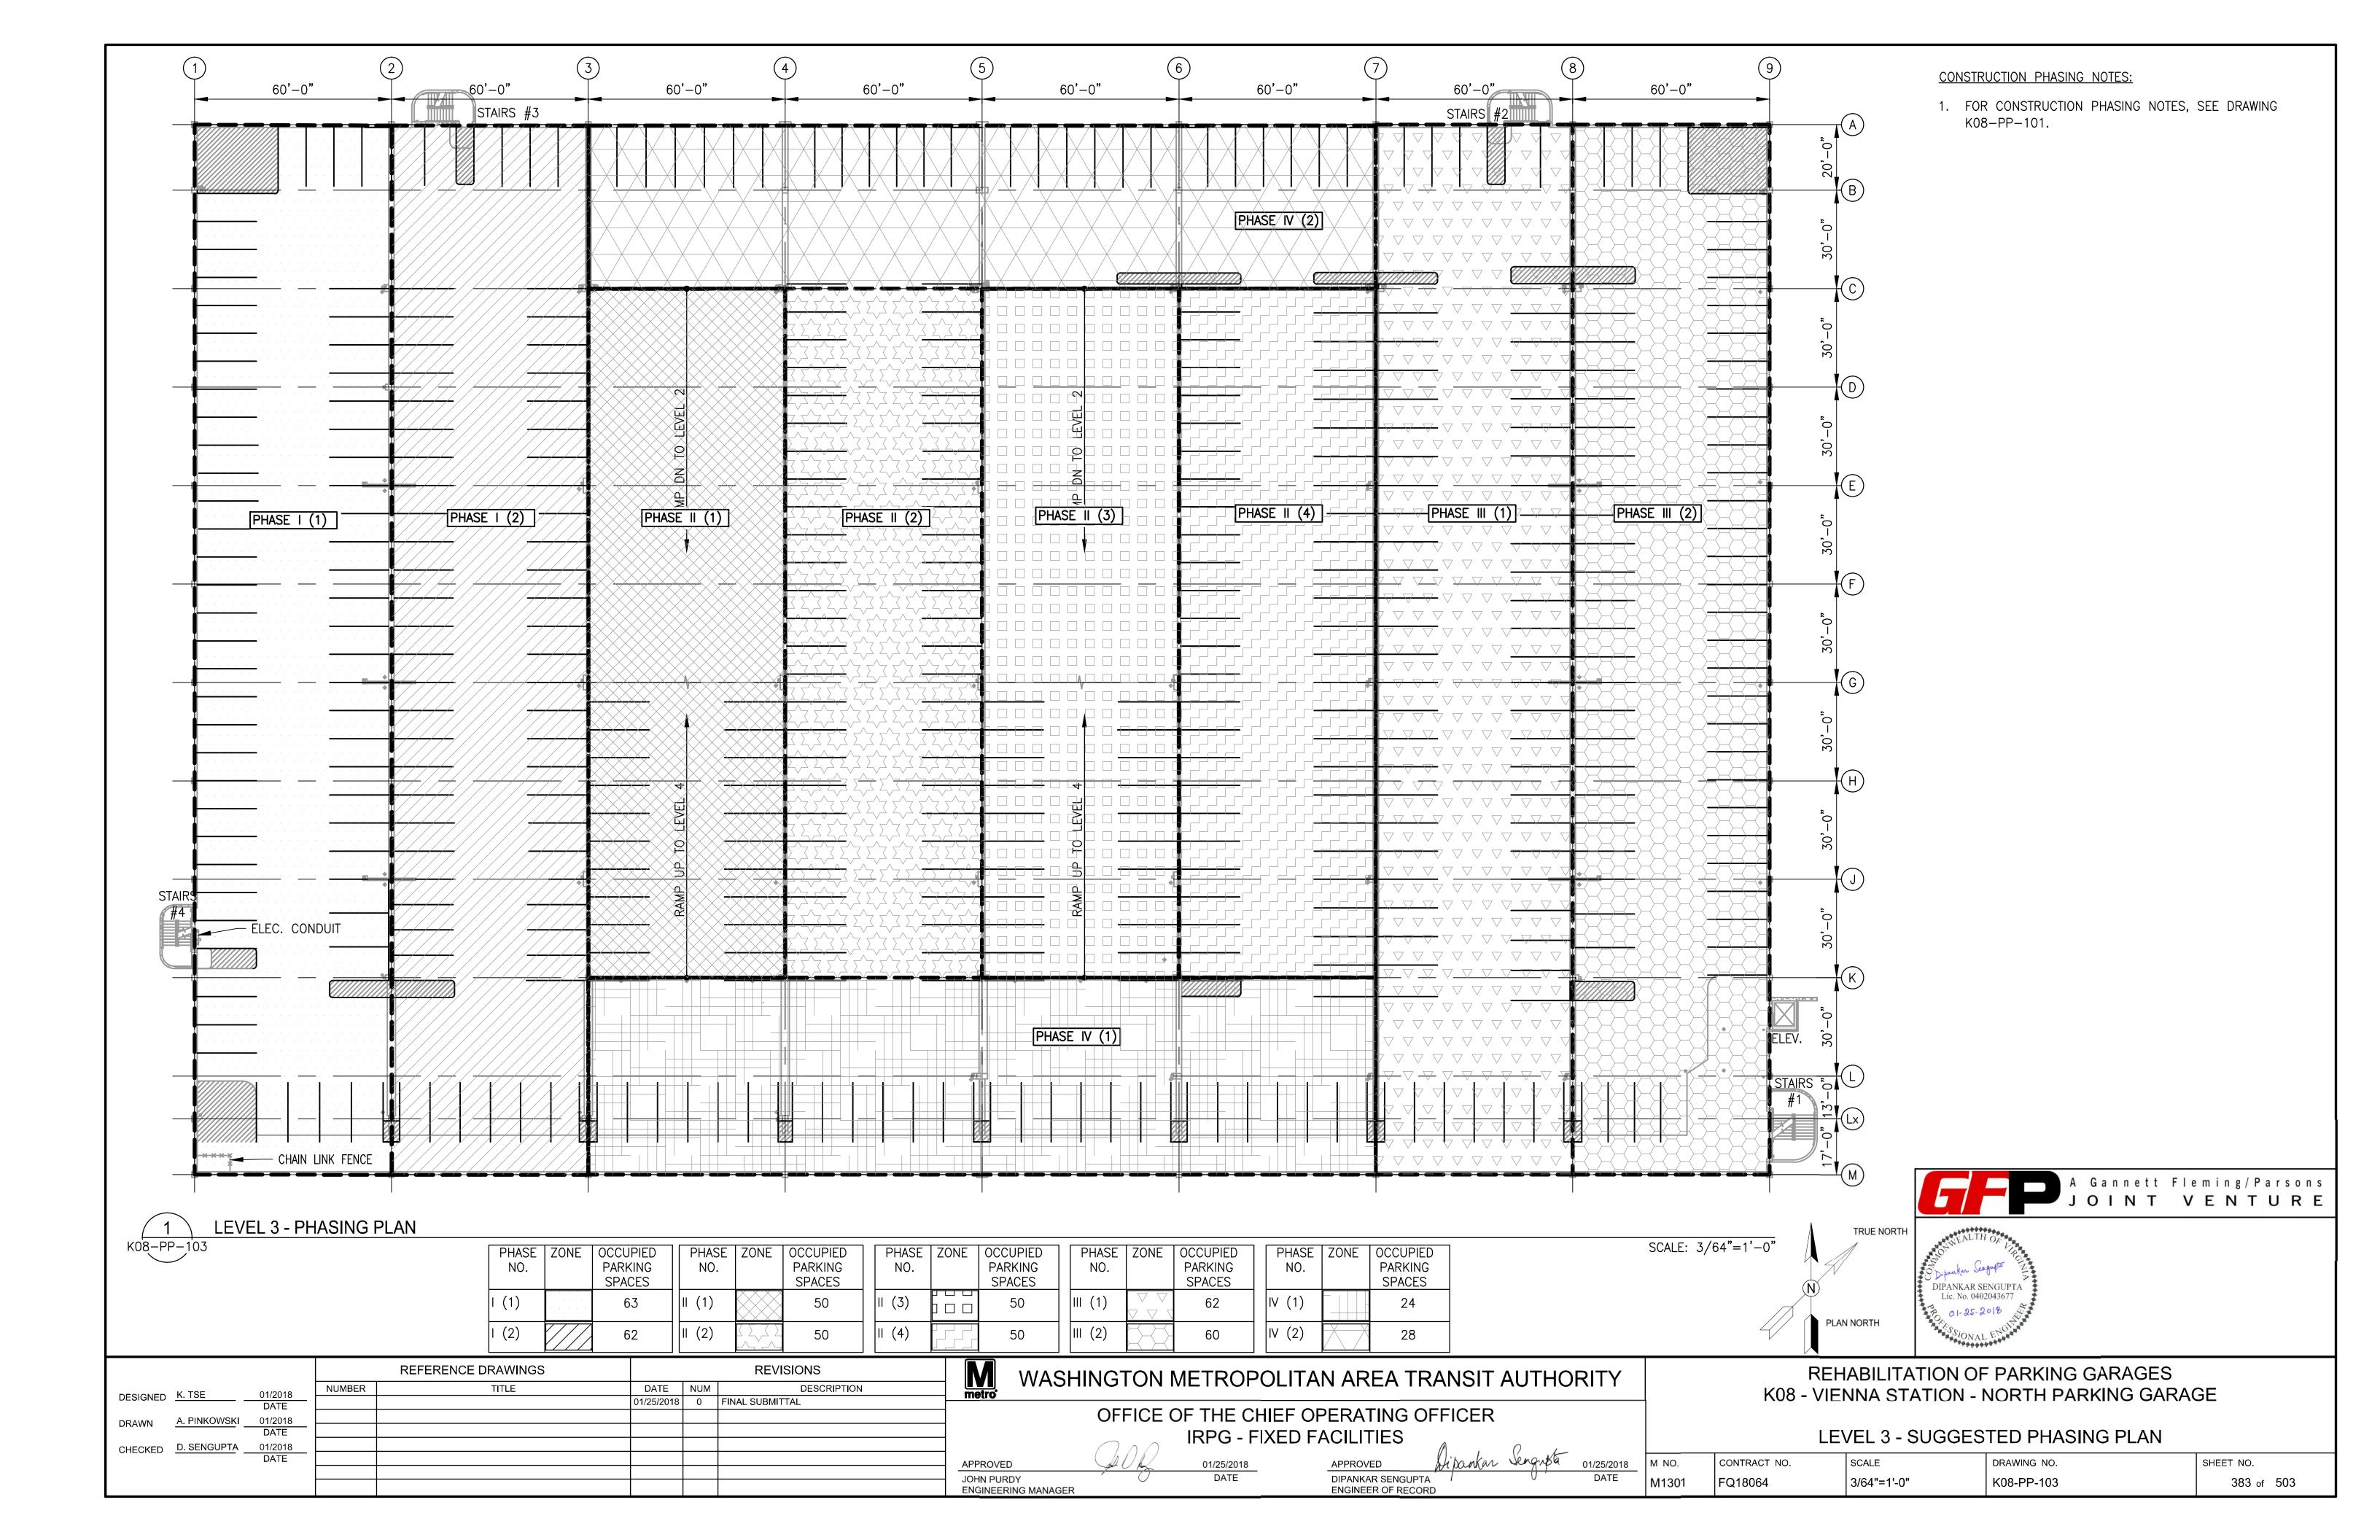
REHABILITATION OF PARKING GARAGES K08 - VIENNA STATION - NORTH PARKING GARAGE


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CODES AND STANDARDS:

- 1. THESE DRAWINGS HAVE BEEN PREPARED IN ACCORDANCE WITH THE FOLLOWING CODES AND STANDARDS (USE THE LATEST EDITIONS UNLESS NOTED OHERWISE):
 - 1.1 2015 INTERNATIONAL BUILDING CODE.
 - "MINIMUM DESIGN LOADS FOR BUILDINGS AND OTHER STRUCTURES": ASCE 7-10, AMERICAN SOCIETY OF CIVIL ENGINEERS.
 - 1.3 "BUILDING CODE REQUIREMENTS FOR STRUCTURAL CONCRETE (ACI 318-14)", AMERICAN CONCRETE INSTITUTE.
 - 1.4 "OCCUPATIONAL SAFETY AND HEALTH ADMINISTRATION" (OSHA) SECTION 1926
 - "MANUAL ON UNIFORM TRAFFIC CONTROL DEVICES FOR STREETS AND HIGHWAYS" 2015.

STRUCTURAL CONSTRUCTION NOTES

- 1. ALL EXISTING DIMENSIONS SHOWN ARE APPROXIMATE AND SHALL BE FIELD VERIFIED BY THE CONTRACTOR.
- 2. STRUCTURAL DRAWINGS MUST BE USED IN CONJUNCTION WITH SPECIFICATIONS, AND OTHER DISCIPLINES DRAWINGS DURING ALL PHASES OF CONSTRUCTION. DISCREPANCIES BETWEEN ENGINEERING DRAWINGS SHALL BE BROUGHT TO THE ATTENTION OF THE ENGINEER FOR CLARIFICATION BEFORE COMMENCING WORK.
- 3. CONTRACTOR SHALL MAINTAIN SAFEGUARDS NECESSARY TO PROTECT PERSONS AND PROPERTY FROM INJURY OR DAMAGE DURING THE PERFORMANCE OF THE WORK. OSHA, STATE, COUNTY AND MUNICIPAL CODES SHALL BE FOLLOWED.
- 4. THE PARKING FACILITY SHALL REMAIN IN SERVICE DURING THE ENTIRE PROJECT CONSTRUCTION EXECUTION. MAINTAIN AT LEAST TWO MEANS OF EMERGENCY AND EGRESS EXITS, ROUTES AND ACCESS TO ELEVATORS FROM EACH PARKING LEVEL DURING THE PROJECT CONSTRUCTION EXECUTION. CONTRACTOR SHALL PROVIDE TEMPORARY SIGNAGE DIRECTING PATRONS TO OPERATIONAL STAIRS AND ELEVATORS.
- 5. STAGING AREAS ARE TO BE KEPT CLEAN OF DEBRIS AND DIRT ON A DAILY BASIS, CONTRACTOR IS RESPONSIBLE FOR ALL MAINTENANCE AND CLEANING OF THESE AREAS DURING THE COURSE OF THE PROJECT.
- 6. CONTRACTOR SHALL PROTECT ALL EXISTING LANDSCAPED AREAS IN THE VICINITY WHERE WORK IS TO BE PERFORMED.
- 7. INFORMATION IN SECTIONS AND DETAILS SHOWN ON DRAWINGS ARE TYPICAL FOR THE ENTIRE PROJECT AND SHALL BE CONSIDERED TYPICAL FOR SIMILAR SITUATIONS NOT SHOWN.
- 8. CONTRACTOR SHALL VERIFY ALL DIMENSIONS PRIOR TO PRODUCING SHOP DRAWINGS, FABRICATING COMPONENTS, OR ORDERING MATERIALS, ALL SHOP DRAWINGS SHALL SHOW DIMENSIONS FIELD VERIFIED BY THE CONTRACTOR.
- 9. THE QUANTITIES OF DETERIORATION SHOWN ON THE BID SCHEDULE ARE APPROXIMATE AND CAN VARY IN THE FIELD. ACTUAL FIELD CONDITIONS MAY WARRANT MODIFICATIONS TO THE CONSTRUCTION DETAILS. AREAS OF NEW DETERIORATION THAT HAVE OCCURRED AFTER THE COMPLETION OF THE CONDITION SURVEY INSPECTION ARE ALSO TO BE EXPECTED. THE CONTRACTOR SHALL SOUND ALL CONCRETE SURFACES AND MARK ALL AREAS OF CONCRETE DETERIORATION IN NEED OF REPAIR. THE LAYOUT SHALL BE VERIFIED AND APPROVED BY THE ENGINEER OF RECORD.
- 10. ALL INFORMATION SHOWN ON DRAWINGS HAVE BEEN PREPARED BASED ON AVAILABLE DOCUMENTS AND FIELD CONDITIONS. NO MATERIAL TESTING WAS PERFORMED.
- 11. CONTRACTOR SHALL SUBMIT SHORING PLANS WITH PROCEDURE AND SHOP DRAWING FOR APPROVAL PRIOR TO CONSTRUCTION. SEE SHORING DETAIL ON DRAWING S-510. PHASING BASED ON POTENTIAL NEED FOR SHORING THREE LEVELS BELOW THE WORK AREA FOR BEARING PAD REPLACEMENT FOR EACH PHASE AREA, NO MORE THAN FOUR LEVELS WITHIN PHASE AREA SHALL BE CLOSED AT A TIME (ONE FOR WORK AND THREE FOR SHORING BELOW) IN ORDER TO MINIMIZE OCCUPIED PARKING SPACES.
- 12. CONTRACTOR SHALL REPAIR OR REPLACE ANY DAMAGE TO CONDUITS THAT RESULT FROM THE SCOPE OF WORK.
- 13. CONTRACTOR SHALL PROVIDE TRAFFIC SIGNAGE DURING CONSTRUCTION AS PER MANUAL ON UNIFORM TRAFFIC CONTROL DEVICES ISSUED BY THE FEDERAL HIGHWAY ADMINISTRATION
- 14. THE TOTAL NUMBER OF PARKING SPACES THAT CAN BE TAKEN OUT OF SERVICE SHALL BE LIMITED TO A MAXIMUM OF 250 SPACES AT A GIVEN TIME. PROVIDE TWO WEEKS ADVANCE NOTICE ON ALL 250 PARKING SPACES BEFORE TAKING PARKING SPACES FOR REHABILITATION
- 15. TOTAL NUMBER OF HANDICAP PARKING SPACES SHALL BE MAINTAINED THROUGHOUT CONSTRUCTION DURATION. PROVIDE TEMPORARY HANDICAP SPACES AS REQUIRED AT OR NEAR ELEVATORS.
- 16. CONTRACTOR SHALL PROVIDE DEBRIS FALL PROTECTION BENEATH THE EXPANSION JOINT DURING REPLACEMENT ACTIVITIES.

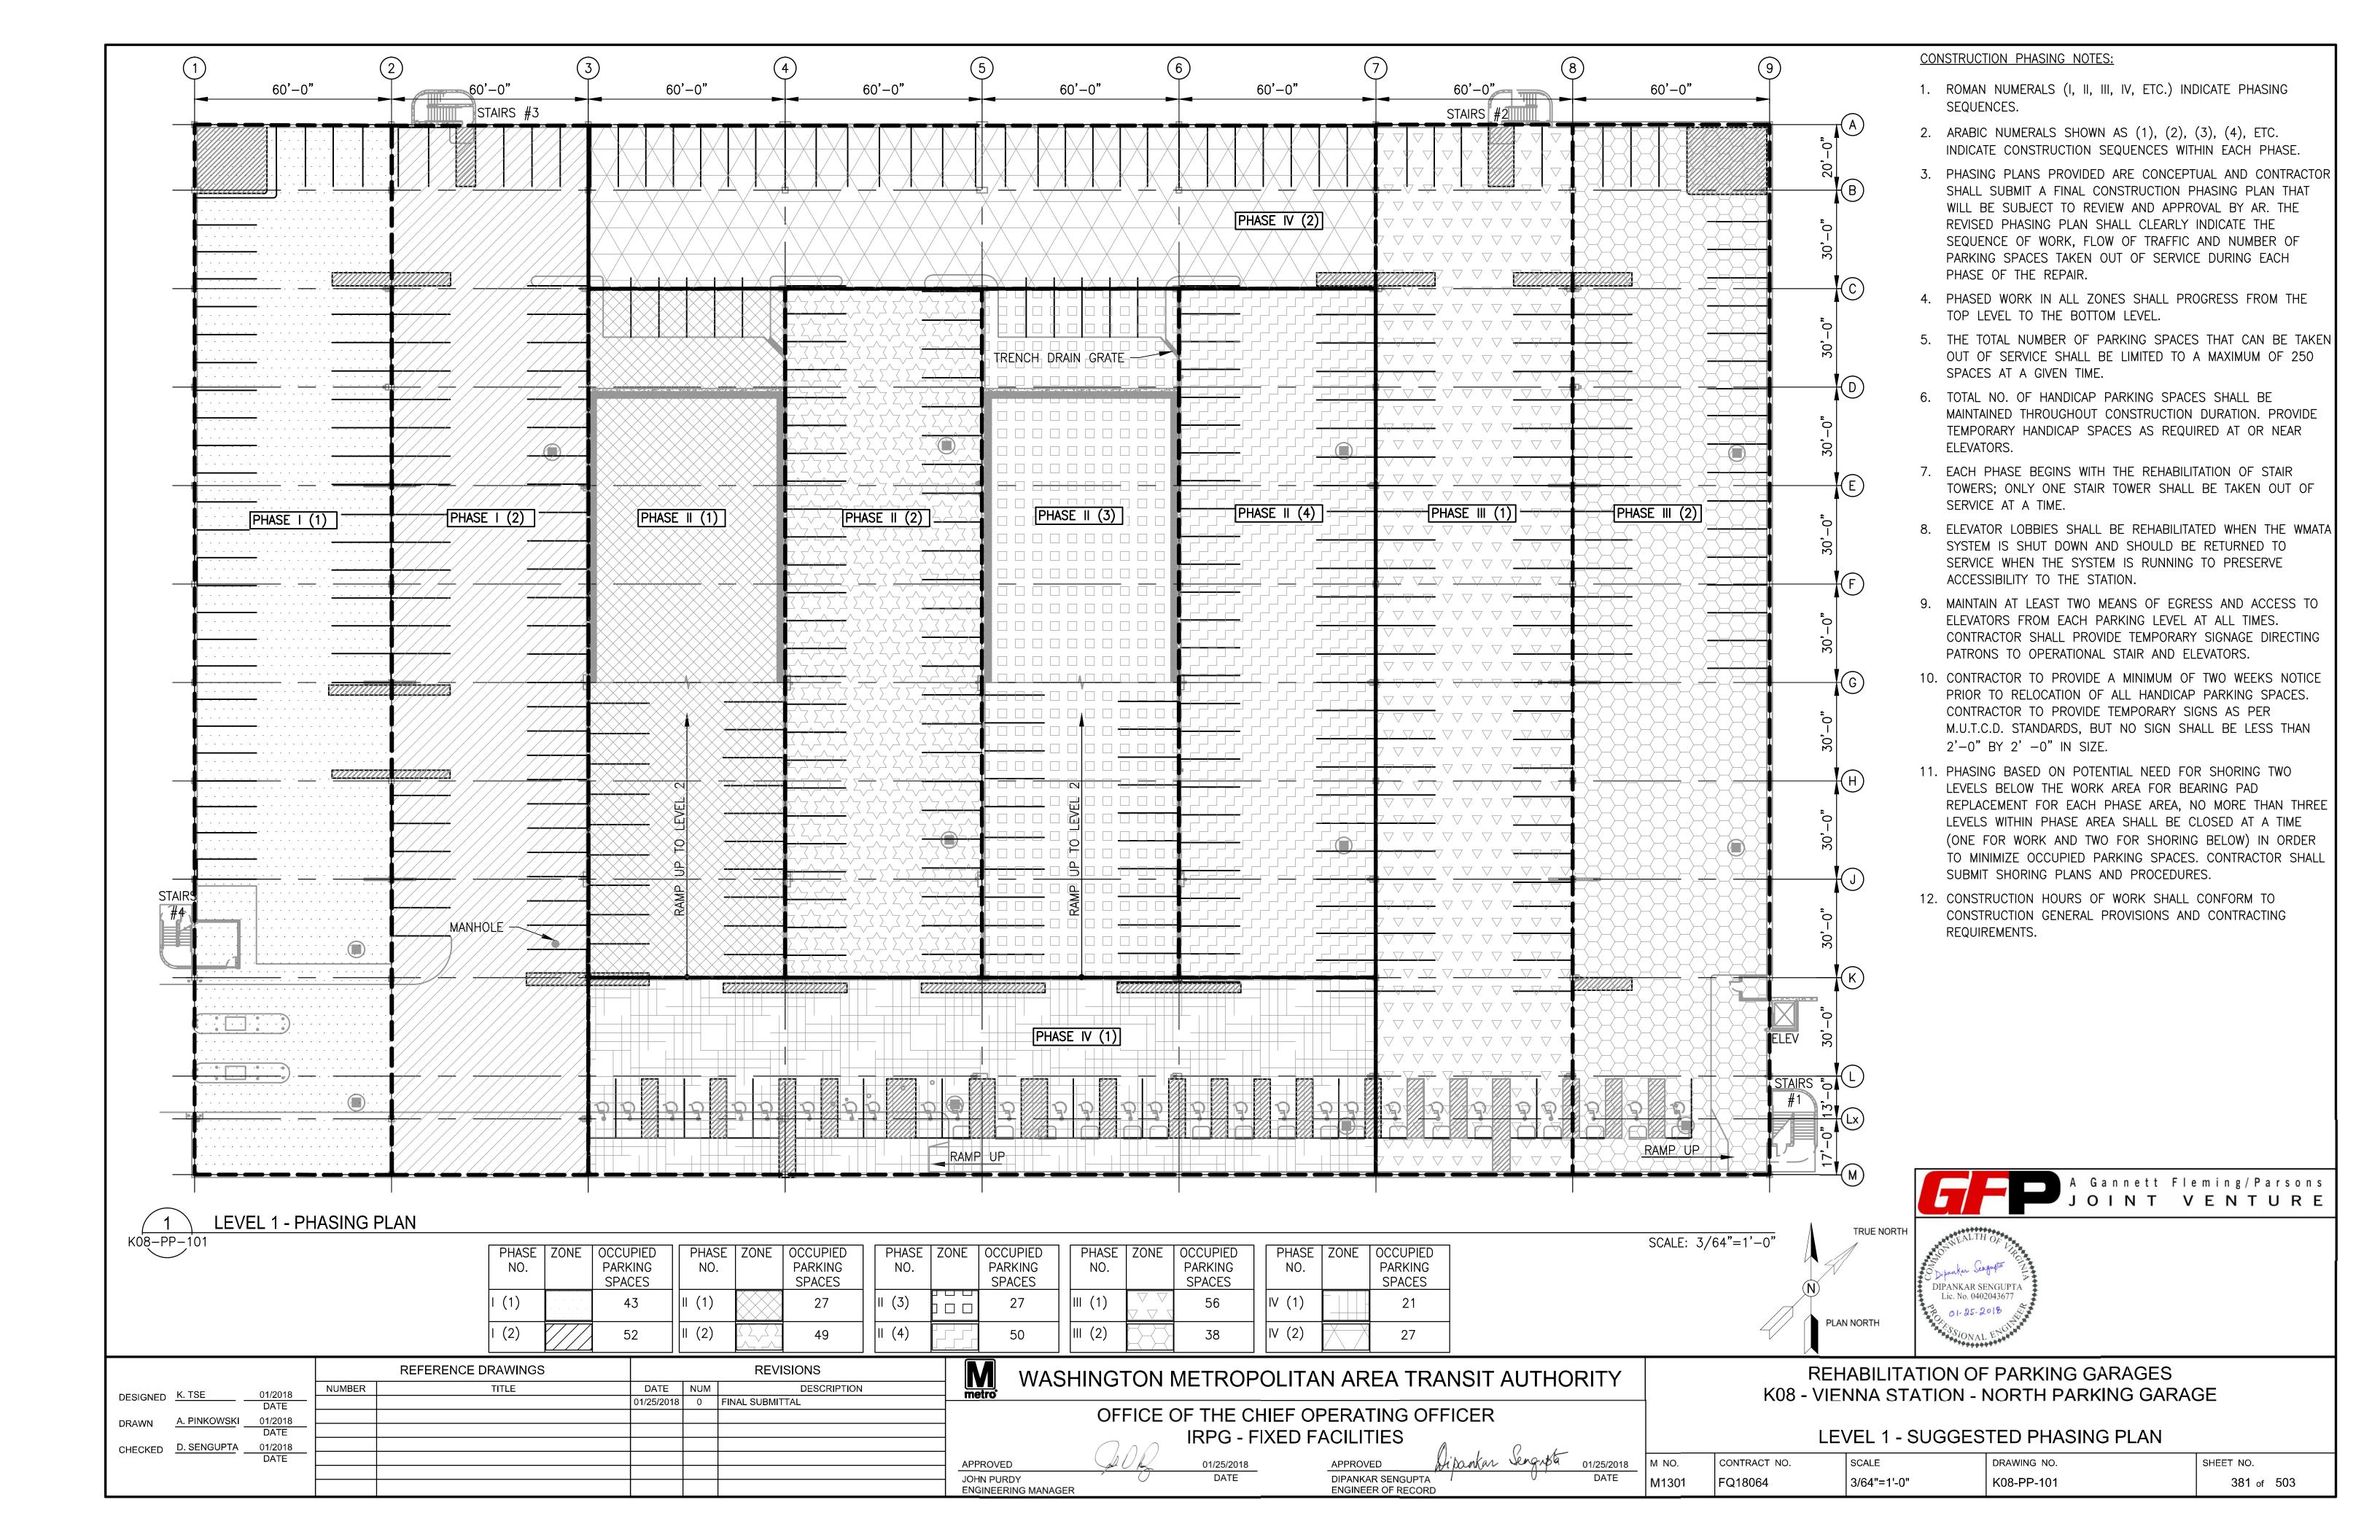REFERENCE DRAWINGS

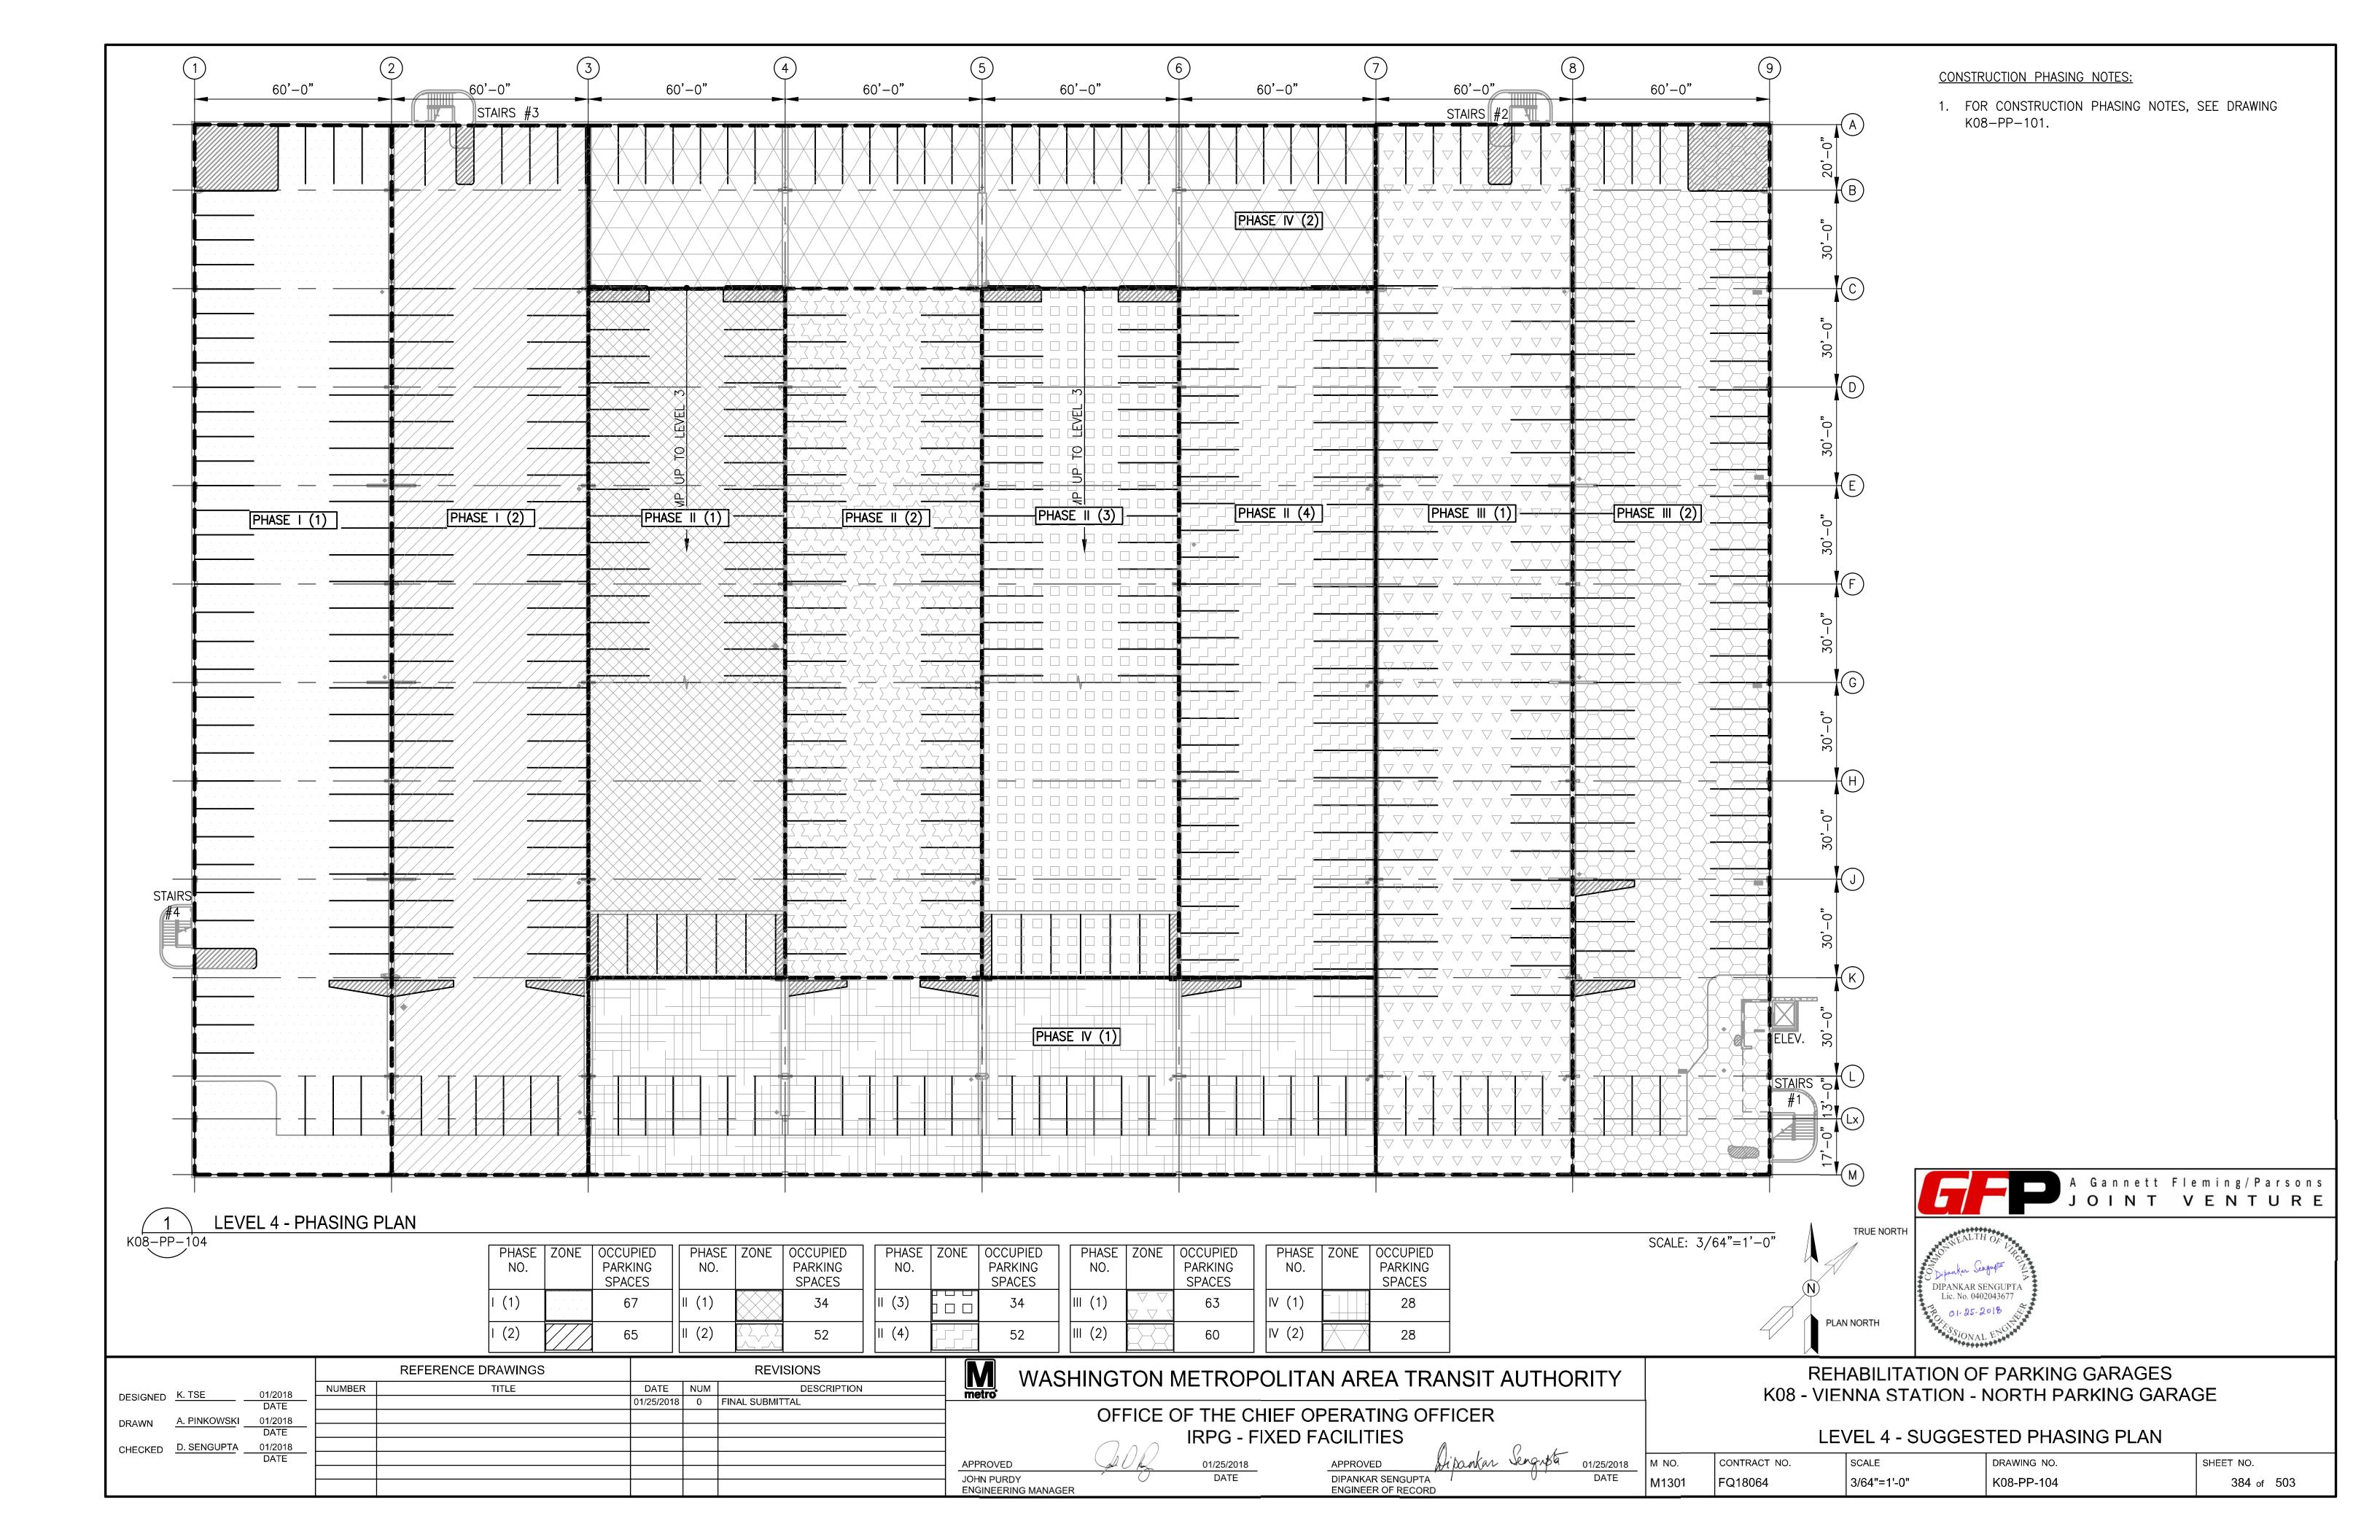DESIGNED K. TSE

CHECKED D. SENGUPTA 01/2018

GENERAL STRUCTURAL NOTES

- 17. CONTRACTOR SHALL PROVIDE TWO WEEKS NOTICE PRIOR REMOVAL AND RELOCATION OF HANDICAPPED PARKING SPACES AND SIGNS DUE TO CONSTRUCTION. MINIMUM SIZE OF SIGNS AS PER INTERNATIONAL BUILDING CODE-2015 SHALL BE NO LESS THAN 2'-0" BY 2'-0" IN SIZE.
- 18. PROVIDE 28"X36" COROPLAST OR EQUIVALENT SIGN AT SIX LOCATIONS ON EACH GARAGE PER WMATA APPROVED LOCATION. THE SIGN SHALL STATE DURATION OF PROJECT AT START DATE AND GENERAL NOTICE IN ENGLISH AND SPANISH.
- 19. ELEVATOR LOBBIES SHALL BE REHABILITATED WHEN THE GARAGE IS SHUT DOWN AND SHALL BE RETURNED TO SERVICE WHEN THE SYSTEM IS RUNNING TO PRESERVE ACCESSIBILITY TO THE STATION.
- 20. CONSTRUCTION PHASING SHALL OCCUR ONE LEVEL AT A TIME CONSECUTIVELY, BEGINNING WITH TOP TIER AND ENDING WITH GROUND LEVEL. CONTRACTOR SHALL NOT BEGIN WORK ANY ADDITIONAL PHASES WITHOUT APPROVAL OF COMPLETING WORK IN A PREVIOUS PHASE.
- 21. CONTRACTOR MUST PROVIDE THE RIGHT OF WAY CLEARANCES TO PUBLIC DURING CONSTRUCTION PHASES ON LEVELS.

CONCRETE NOTES

- 1. ALL CONCRETE/MORTAR REPAIRS ARE TO INCLUDE AN EPOXY BONDING AGENT UNLESS INDICATED OTHERWISE, BONDING AGENT SHALL BE APPLIED TO ALL CONCRETE/MORTAR REPAIR AREAS PRIOR TO THE APPLICATION OF REPAIR MATERIALS. UNLESS NOTED OTHERWISE.
- 2. STEEL REINFORCING BARS SHALL CONFORM TO ASTM A615, GRADE 60.
- 3. WELDED WIRE FABRIC SHALL CONFORM TO ASTM A185.
- 4. UNLESS NOTED OTHERWISE, BARS AT SPLICES ARE TO BE LAPPED IN ACCORDANCE WITH THE TABLE "MINIMUM REINFORCEMENT LAP SPLICES AND EMBEDMENTS" AS FOLLOWS:

REINFO	ORCIN	G STE	EL LAP	SPLIC	ES AN	D EMB	EDME	NTS	
BAR	MINIMU		SPLICE LE HES)	ENGTH	MINIMUM EMBEDMENT LENGTH (INCHES)				
SIZE	TOP E	BARS	OTHER	RBARS	TOP E	BARS	OTHER	RBARS	
CLEAR COVER	< 2"	<u>></u> 2"	< 2"	<u>></u> 2"	< 2"	<u>></u> 2"	< 2"	<u>></u> 2"	
3	14	14	12	12	12	12	12	12	
4	19	19	14	14	14	14	12	12	
5	27	23	21	18	21	18	16	14	
6	38	28	29	21	29	21	22	17	
7	61	40	47	31	47	31	36	24	
8	76	46	59	35	59	35	45	27	
9	93	57	71	44	71	44	55	34	
10	112	70	87	54	87	54	67	42	
11	133	84	102	65	102	65	79	50	

NOTES:

- 1. TABLE BASED ON ACI 318-14 WITH f'c = 5.000 PSI AND f'y = 60,000 PSI.
- TOP BARS ARE HORIZONTAL BARS WITH MORE THAN 12" DEPTH OF
- CONCRETE CAST BELOW THE REINFORCEMENT.
- HORIZONTAL WALL REINFORCEMENT IS CONSIDERED A TOP BAR. CLEAR COVER = CONCRETE COVER FOR REINFORCEMENT BARS.
- FOR EPOXY-COATED BARS, MULTIPLY THE TABULATED VALUES BY 1.2.
- 6. FOR f'c=4.000 PSI, MULTIPLY THE TABULATED VALUES BY 1.1.
- 5. CONCRETE COVER FOR REINFORCEMENT BARS SHALL CONFORM TO THE FOLLOWING, UNLESS NOTED OTHERWISE ON DRAWINGS:
 - a. UNFORMED SURFACES IN CONTACT WITH GROUND
- 3 INCHES
- b. FORMED SURFACES IN CONTACT WITH GROUND OR EXPOSED TO WEATHER AND ALL WALLS
- 2 INCHES

c. COLUMNS AND BEAMS

REVISIONS

DESCRIPTION

DATE NUM

01/25/2018 0 | FINAL SUBMITTAL

- $1 \frac{1}{2}$ INCHES
- d. EXTERIOR EXPOSURE. TOP OF SLABS

- $1 \frac{1}{2}$ INCHES

REHABILITATION OF PARKING GARAGES

DIPANKAR SENGUPTA Lic. No. 0402043677

A Gannett Fleming/Parsons

JOINT VENTURE

GENERAL STRUCTURAL NOTES CONTRACT NO. SCALE DRAWING NO. SHEET NO. M NO. FQ18064 NONE M1301 K08-S-001 385 of 503

WASHINGTON METROPOLITAN AREA TRANSIT AUTHORITY

OFFICE OF THE CHIEF OPERATING OFFICER

IRPG - FIXED FACILITIES APPROVED

01/25/2018 DATE

DIPANKAR SENGUPTA JOHN PURDY ENGINEERING MANAGER

librarkar Jengusa 01/25/2018 ENGINEER OF RECORD

K08 - VIENNA STATION - NORTH PARKING GARAGE

6. CHAMFER EXPOSED CONCRETE EDGES TO MATCH EXISTING.

DIAMETER THAN DOWEL/ANCHOR DIAMETER.

AS SHOWN ON DRAWINGS.

USED FOR ALL WELDS.

START OF REPAIR WORK.

THE STRUCTURE TO REMAIN.

ENGINEER OF RECORD.

CONCRETE REPAIR NOTES:

FOLLOWING:

REMOVAL NOTES:

STEEL NOTES

7. DRILLED HOLES FOR EPOXY ANCHORED DOWELS/ANCHORS SHALL BE 1/8 INCH LARGER IN

1. ALL STEEL WIDE FLANGE SHAPES SHALL CONFORM TO A992 GALVANIZED STEEL. ALL OTHER STEEL

SHAPES AND PLATES SHALL CONFORM TO ASTM A36 GALVANIZED UNLESS NOTED OTHERWISE.

2. ANCHORS SHALL BE GALVANIZED OR STAINLESS STEEL EXPANSION ANCHORS OR APPROVED EQUAL

3. WELDING SHALL BE COMPLY WITH THE LATEST AWS 1.1 CODE. E70XX ELECTRODES SHALL BE

1. THE LOCATION AND EXTENT OF EACH TYPE OF REPAIR IS SHOWN ON THE DRAWINGS. THE C.M. AND THE CONTRACTOR SHALL JOINTLY INSPECT EACH ITEM TO BE REPAIRED. THE CONTRACTOR

2. CONCRETE REPAIRS SHALL BE COMPLETED IN THE FOLLOWING ORDER: SPALL REPAIRS. CRACK

3. PATCHING SHALL NOT BE PERFORMED AT ANY LOCATION UNTIL THE C.M. HAS APPROVED THE

(b) THE REINFORCEMENT, INCLUDING ADEQUATE CONCRETE REMOVAL, ADEQUATE REINFORCEMENT

1. REMOVE OR DEMOLISHED MATERIALS SHALL NOT BE ALLOWED TO FALL, DROP OR IMPACT AGAINST

2. AREAS DAMAGED BY REMOVALS / DEMOLITION SHALL BE REPAIRED TO THE SATISFACTION OF THE

CLEAN SURFACES TO BE PATCHED OF ALL MATERIAL WHICH IS NOT SOUND CONCRETE OR

STEEL AND ADEQUATE REINFORCEMENT STEEL SUPPORT AND COVER. JUST PRIOR TO PATCHING,

REBAR, AND SATURATE WITH WATER TO PRODUCE A SURFACE-SATURATED DRY CONDITION (WITH

REPAIR BY EPOXY INJECTION AND APPLICATION OF PROTECTIVE COATINGS.

(a) THE SURFACES TO RECEIVE PATCHING MATERIAL

NO STANDING WATER) DURING APPLICATION.

SHALL QUANTIFY ANY ADDITIONAL REPAIRS AND GET APPROVAL FROM THE C.M. PRIOR TO THE

STRUCTURAL REPAIR KEY NOTES, ABBREVIATIONS, AND SYMBLOLS

KEYNOTES

- TYPICAL EXPANSION JOINT REPAIR, SEE DETAIL 1 ON DRAWING S-501
- TYPICAL SEALANT REPAIR AT TOOLED JOINT, SEE DETAIL 2 ON DRAWING S-501
- TYPICAL SEALANT REPAIR AT DOUBLE TEE BEAM JOINT, SEE DETAIL 3 ON DRAWING S-502.
- TYPICAL DOUBLE TEE BEAM FLANGE SPALL WITH SEALANT DETAIL, SEE DETAIL 4 ON DRAWING S-502.
- TYPICAL DOUBLE TEE BEAM FLANGE SPALL REPAIR DETAIL, SEE DETAIL 5 ON DRAWING S-503.
- TYPICAL VERTICAL JOINT SEALANT REPAIR, SEE DETAIL 6 ON DRAWING S-503.
- TYPICAL UNDERSIDE CRACK REPAIR, SEE DETAIL 7 ON DRAWING S-504.
- TYPICAL TOP SIDE CRACK REPAIR, SEE DETAIL 8 ON DRAWING S-504.
- TYPICAL VERTICAL CRACK REPAIR, SEE DETAIL 9 ON DRAWING S-505.
- TYPICAL VERTICAL SPALL REPAIR. SEE DETAIL 10 ON DRAWING S-505.
- TYPICAL CONCRETE TOP SIDE SPALL REPAIR, SEE DETAIL 11 ON DRAWING S-506.
- TYPICAL FULL DEPTH SPALL REPAIR AT UNDERSIDE OF CONCRETE DECK, SEE DETAIL 12 ON DRAWING S-506.
- TYPICAL DEEP SPALL REPAIR AT UNDERSIDE OF CONCRETE DECK, SEE DETAIL 13 ON DRAWING S-507
- TYPICAL REPAIR AT HORIZONTAL LIFTING POINT, SEE DETAIL 14 ON DRAWING S-507.
- TYPICAL DETERIORATED CONCRETE WASH REPAIR, SEE DETAIL 15 ON DRAWING S-508.
- TYPICAL DOUBLE TEE WEB SPALL REPAIR, SEE DETAIL 16 ON DRAWING S-508
- TYPICAL CONNECTION PLATE REPAIR, SEE DETAIL 17 ON DRAWING S-509
- TYPICAL DOUBLE TEE BEARING PAD REPLACEMENT, SEE DETAIL 18 ON DRAWING S-510.
- TYPICAL UNEVEN JOINT AT DOUBLE TEE FLANGES, SEE DETAIL 19 ON DRAWING S-511.
- TYPICAL CONCRETE CURB REPAIR, SEE DETAIL 20 ON DRAWING S-511.
- TYPICAL CMU WALL CRACK REPAIR AT DOUBLE TEE, SEE DETAIL 21 ON DRAWING S-512.
- TYPICAL TRAFFIC TOPPING REPAIR AT PARAPET WALL, SEE DETAIL 22 ON DRAWING S-512.
- TYPICAL TRAFFIC BEARING MEMBRANE, SEE DETAIL 23 ON DRAWING S-513.
- TYPICAL TRAFFIC BOLLARD REPAIR, SEE DETAIL 24 ON DRAWING S-513
- INSTALL NEW PLASTIC CAP AT VERTICAL LIFTING POINT., SEE DETAIL 25 ON DRAWING S-514.
- LOCATIONS MARKED ON PLANS WITH PONDING AREA SHALL BE CLEANED AND REPAIRED WITH CONCRETE TOPPING TO PROVIDE APPROPRIATE DRAINAGE SLOPE. SEE DETAIL 26 ON DRAWING S-514.
- LOCATIONS MARKED ON PLANS WITH EFFLORESCENCE OR RUST STAINING SHALL BE CLEANED AND SEALED BY POWER WASHING AND APPLYING EPOXY SEALANT TO THE AREAS MARKED, SEE DETAIL 27 ON DRAWING S-514.
- LOCATIONS MARKED ON PLANS WITH MORTAR/GROUT DETERIORATION AND CRACKED CMU SHALL BE RETOOLED/REGROUTED AND REPLACE CRACKED CMU BLOCK, SEE DETAIL 28 ON DRAWING S-514.
- LOCATIONS MARKED ON PLANS WITH CONNECTION PLATE CORROSION SHALL BE CLEANED AND SEALED BY APPLYING EPOXY SEALANT TO THE AREAS MARKED, SEE DETAIL 29 ON DRAWING S-515.
- LOCATIONS MARKED ON PLANS WITH MAP CRACKING OR HONEYCOMB SHALL BE CLEANED AND COATED WITH WATERPROOFING, SEE DETAIL 30 ON DRAWING S-515.
- LOCATIONS MARKED ON PLANS WITH WATER LEAKING ON WALL SHALL BE CLEANED AND ANY DETERIORATED JOINT SHALL BE REPAIRED. SEE DETAIL 31 ON DRAWING S-515.
- LOCATIONS MARKED ON PLANS WITH CORRODED/MISSING ANCHOR BOLTS SHALL BE INSTALLED WITH NEW ANCHOR BOLTS AND PAINTED, SEE DETAIL 32 ON DRAWING S-515.
- REPLACE PARKING GARAGE STOP CURB, SEE DETAIL 33 ON DRAWING S-516.
- LOCATIONS MARKED ON PLANS WITH DISPLACED ANGLE/MISSING ANCHOR AT EXPANSION JOINT SUPPORT SHALL BE REALIGNED AND INSTALLED WITH NEW ANCHOR AND PAINT, SEE DETAIL 34 ON DRAWING S-516.
- LOCATIONS MARKED ON PLANS WITH CORROSION AT WELDING SHALL BE CLEANED AND GALVANIZE COATING TO BE PROVIDED, SEE DETAIL 35 ON DRAWING S-516.
- TYPICAL REPAIR AT CRACK PARALLEL TO EXPANSION JOINT, SEE DETAIL 36 ON DRAWING S-517.
- TYPICAL INVERTED TEE SPALL REPAIR, SEE DETAIL 37 ON DRAWING S-517.
- TYPICAL STAIR NOSING REPAIR, SEE DETAIL 38 ON DRAWING S-518
- TYPICAL SILANE SEALER COATING SYSTEM, SEE DETAIL 39 ON DRAWING S-519.
- TYPICAL MINOR LONGITUDINAL CRACK REPAIR AT UNDERSIDE OF DOUBLE TEE, SEE DETAIL 40 ON DRAWING S-519.

TYPICAL GUIDELINE FOR EXPOSING AND UNDERCUTTING REINFORCING STEEL

PREPARED **AUTHORITY'S REPRESENTATIVE** CONCRETE CORRODED BARS BOTTOM OF SURFACES TO BOTTOM OF STEEL RECEIVE PATCH 'MIN. CLEARANCE **CENTERLINE** REFER TO NOTE 2 CONSTRUCTION MANAGER CONCRETE MASONRY UNITS CONCRETE DIAMETER **DRAWING** EACH WAY **ELEVATION EXISTING EXPANSION JOINT** EXP. JT **EMBED EMBEDMENT** FLOOR DRAIN FOOT/FEET

SECTION THROUGH CONCRETE MEMBER


UNCORRODED & TIGHTLY BONDED BARS

REFER TO NOTE 4

CAUTION: BEFORE STARTING REMOVALS, REVIEW EFFECT OF REMOVALS ON STRUCTURAL INTEGRITY. PROVIDE SHORING OF MEMBERS AS NECESSARY.

- REMOVE LOOSE OR DELAMINATED CONCRETE ABOVE CORRODED REINFORCING STEEL. ONCE INITIAL REMOVALS ARE MADE, PROCEED WITH THE UNDERCUTTING OF ALL EXPOSED CORRODED BARS UNDERCUTTING WILL PROVIDE CLEARANCE FOR UNDER BAR CLEANING, FULL BAR CIRCUMFERENCE BONDING TO SURROUNDING CONCRETE, AND WILL SECURE THE PATCH STRUCTURALLY.
- PROVIDE MINIMUM 1" CLEARANCE BETWEEN EXPOSED REBARS AND SURROUNDING CONCRETE OR 1/4" LARGER THAN LARGEST AGGREGATE IN REPAIR MORTAR. WHICHEVER IS GREATER
- CONCRETE REMOVALS SHALL EXTEND ALONG THE BARS TO LOCATIONS ALONG THE BAR FREE OF BOND INHIBITING CORROSION. AND WHERE THE BAR IS WELL BONDED TO SURROUNDING CONCRETE
- IF UNCORRODED REINFORCING STEEL IS EXPOSED DURING THE UNDERCUTTING PROCESS, CARE SHALL BE TAKEN NOT TO DAMAGE THE BAR'S BOND TO SURROUNDING CONCRETE. IF BOND BETWEEN BAR AND CONCRETE IS BROKEN, AS DETERMINED BY THE A.R. UNDERCUTTING OF THE BAR SHALL BE REQUIRED
- 5. ANY REINFORCEMENT WHICH IS LOOSE SHALL BE SECURED IN PLACE BY TYING TO OTHER SECURED BARS OR BY OTHER APPROVED METHODS.
- 6. TAKE EXTRA PRECAUTION NOT TO DAMAGE REINFORCEMENT WHEN REMOVING CONCRETE.
- 7. APPLICABLE TO HORIZONTAL, VERTICAL AND OVERHEAD LOCATIONS UNLESS OTHERWISE NOTED IN DRAWINGS.

TYPICAL GUIDELINE FOR **EDGE AND SURFACE CONDITIONING**

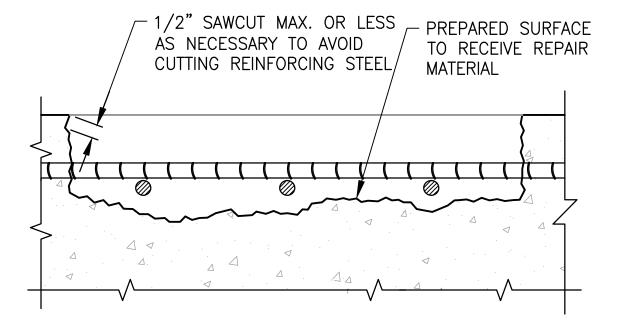


SECTION THROUGH CONCRETE MEMBER


CAUTION: BEFORE STARTING REMOVALS, REVIEW EFFECT OF REMOVALS ON STRUCTURAL INTEGRITY. PROVIDE SHORING OF MEMBERS AS NECESSARY.

NOTES:

- REMOVE DELAMINATED CONCRETE, UNDERCUT REINFORCING STEEL (REFER TO REINFORCING STEEL UNDERCUTTING GUIDELINE), REMOVE ADDITIONAL CONCRETE AS REQUIRED TO PROVIDE MINIMUM REQUIRED THICKNESS OF REPAIR MATERIAL.
- TAKE EXTRA PRECAUTION NOT TO DAMAGE REINFORCEMENT WHEN REMOVING CONCRETE.
- AT EDGE LOCATIONS PROVIDE ANGLE CUTS. AVOID FEATHER EDGES. FOR SHOTCRETE REPAIRS REFER TO ACI 506 EDGE PREPARATION GUIDELINES. PATCH CONFIGURATION SHOULD BE KEPT AS SIMPLE AS POSSIBLE. FOR **EXAMPLE:**

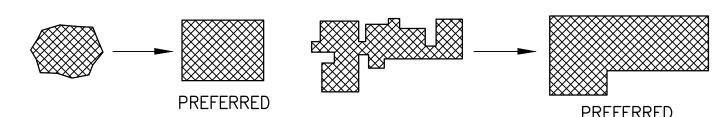

- 4. AFTER REMOVALS AND EDGE CONDITIONING ARE COMPLETE, REMOVE BOND INHIBITING MATERIALS (DIRT. LOOSELY BONDED AGGREGATES) BY ABRASIVE BLASTING OR HIGH PRESSURE WATERBLASTING WITH OR WITHOUT ABRASIVE CHECK THE SURFACE AFTER CLEANING TO ENSURE THAT SURFACE IS FREE FROM ADDITIONAL LOOSE AGGREGATE, OR THAT ADDITIONAL DELAMINATIONS ARE NOT PRESENT.
- APPLICABLE TO HORIZONTAL, VERTICAL AND OVERHEAD LOCATIONS UNLESS OTHERWISE NOTED IN DRAWINGS.

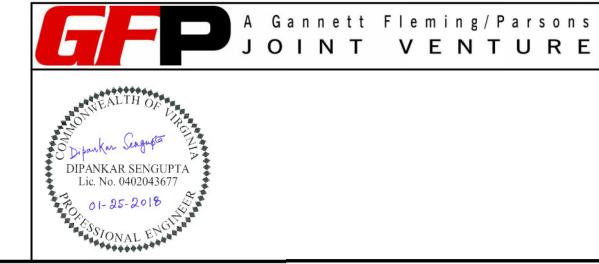

NOTE 1: THE NUMBER OF ARROWS IN KEYNOTE SYMBOL INDICATES DEFECT REGIONS. NOT NUMBER OF DEFECTS. REFER TO REPAIR QUANTITY TABLE IN PLAN FOR NUMBER OF DEFECTS AND REPAIR QUANTITIES.


REPAIR LOCATIONS CAN BE FOUND. SEE NOTE 1

AREA BETWEEN COLUMN LINES WHERE

REHABILITATION OF PARKING GARAGES K08 - VIENNA STATION - NORTH PARKING GARAGE

GENERAL KEY NOTES, ABBREVIATIONS AND SYMBOLS

CONTRACT NO. SCALE DRAWING NO. SHEET NO. M NO. NONE M1301 FQ18064 K08-S-002 386 of 503

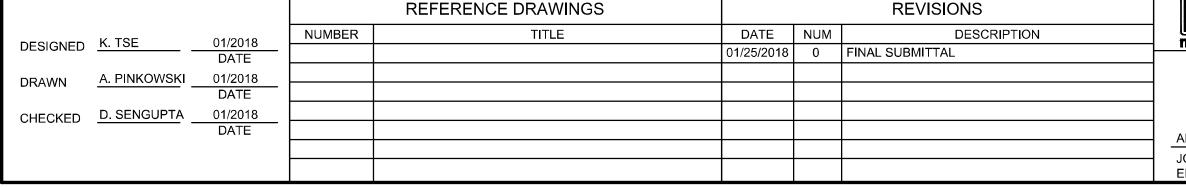

ABBREVIATIONS

B.0.

B.0.S.

C.M.U.

DWG.

E.W.

EXIST.

F.D.

GALV.

MANUF

MAX.

MIN.

NO.

P.S.I.

P.S.F

REINF

THK.

V.I.F.

WWF

SYMBOLS

KEYNOTE SYMBOL

MISC.

FINISH FLOOR

GALVANIZED

INCH/INCHES

INFORMATION

MAXIMUM

MINIMUM

NUMBER

QUANTITY

REQUIRED

THICK

TYPICAL

ELEVATION

STEP SYMBOL

ON CENTER

MANUFACTURER

MISCELLANEOUS

REINFORCEMENT

POUNDS PER SQUARE INCH

POUNDS PER SQUARE FOOT

REPRESENTATIVE ENGINEER

SQUARE FEET PER GALLON

UNLESS NOTED OTHERWISE

KEYNOTE NUMBER

SEE NOTE 1

KEYNOTE NUMBER

REGION WHERE REPAIR

LOCATION(S) CAN BE FOUND.

VERIFY IN THE FIELD

WIRE WELDED FABRIC


WASHINGTON METROPOLITAN AREA TRANSIT AUTHORITY

OFFICE OF THE CHIEF OPERATING OFFICER **IRPG - FIXED FACILITIES**

APPROVED 01/25/2018 JOHN PURDY ENGINEERING MANAGER


hipankar Jengusta DIPANKAR SENGUPTA

01/25/2018 DATE **ENGINEER OF RECORD**

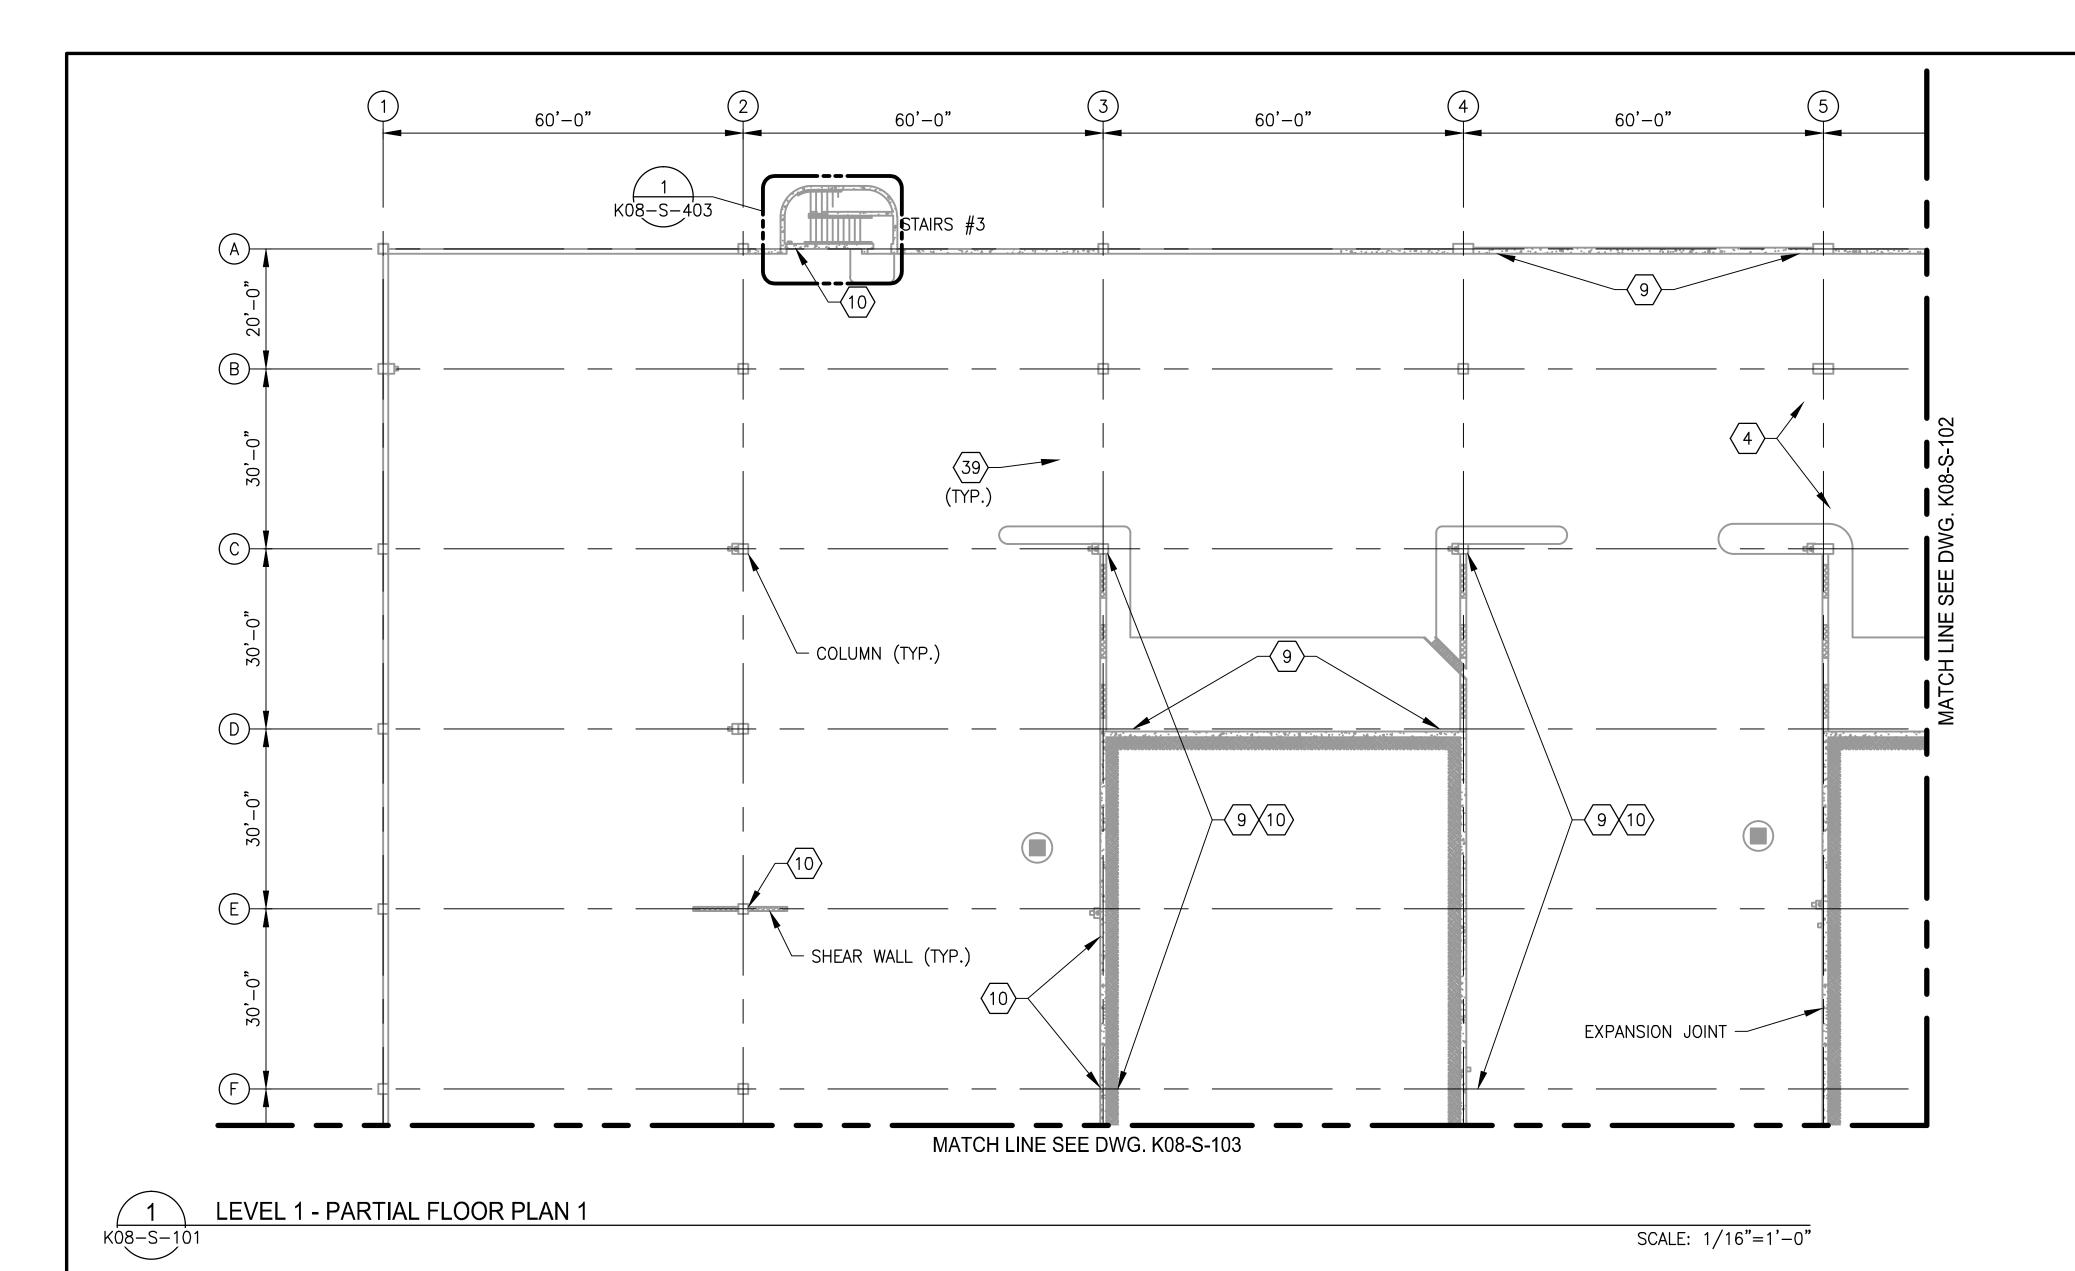


- 1. SEE DRAWING K08-S-002 FOR THE LIST OF KEY NOTES.
- 2. SILANE COATING SHALL BE PROVIDED FOR ENTIRE PARKING AREA.

STRUCTURAL REPAIR QUANTITIES (LEVEL 1) KEY NOTES | QUANTITY | UNIT OF QTY. | NUMBER OF LOCATIONS LF SF 4 53 LF 11 1334 89 LF 10 298 SF 89 SF 14 SF 28 LF 142800 39 SF

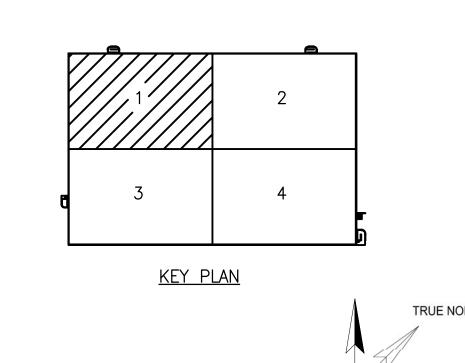

FQ18064

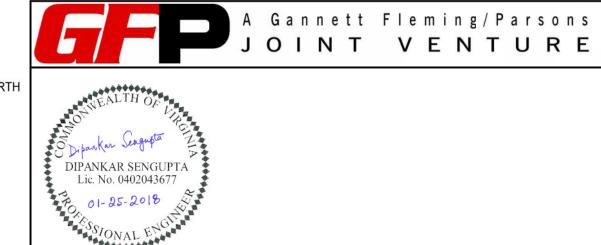

ORTH	ON EALTH OF LIFE
	DIPANKAR SENGUPTA Lic. No. 0402043677
	O 01-25-2018 ET

				REFERENCE DRAWINGS			REVISIONS	M W	/ASHII
DEGLOVED	K TSE	01/2018	NUMBER	TITLE	DATE	NUM	DESCRIPTION	■VI \\ metro*	
DESIGNED	K. TOL	DATE			01/25/2018	0	FINAL SUBMITTAL	IIICUO	
DRAWN	A. PINKOWSKI	01/2018							
DIOWIN		DATE							
CHECKED	D. SENGUPTA	01/2018							
		DATE						APPROVED	
								JOHN PURDY	
								ENGINEERING N	MANAGER

WASHINGTON METROPOLITAN AREA TRANSIT AUTHORITY OFFICE OF THE CHIEF OPERATING OFFICER IRPG - FIXED FACILITIES 01/25/2018

DIPANKAR SENGUPTA ENGINEER OF RECORD


REHABILITATION OF PARKING GARAGES K08 - VIENNA STATION - NORTH PARKING GARAGE LEVEL 1

	PARTIAL FL	OOR PLAN
CONTRACT NO.	SCALE	DRAWING NO.

1/16"=1'-0"

PLAN NORTH

SHEET NO. K08-S-101 387 of 503

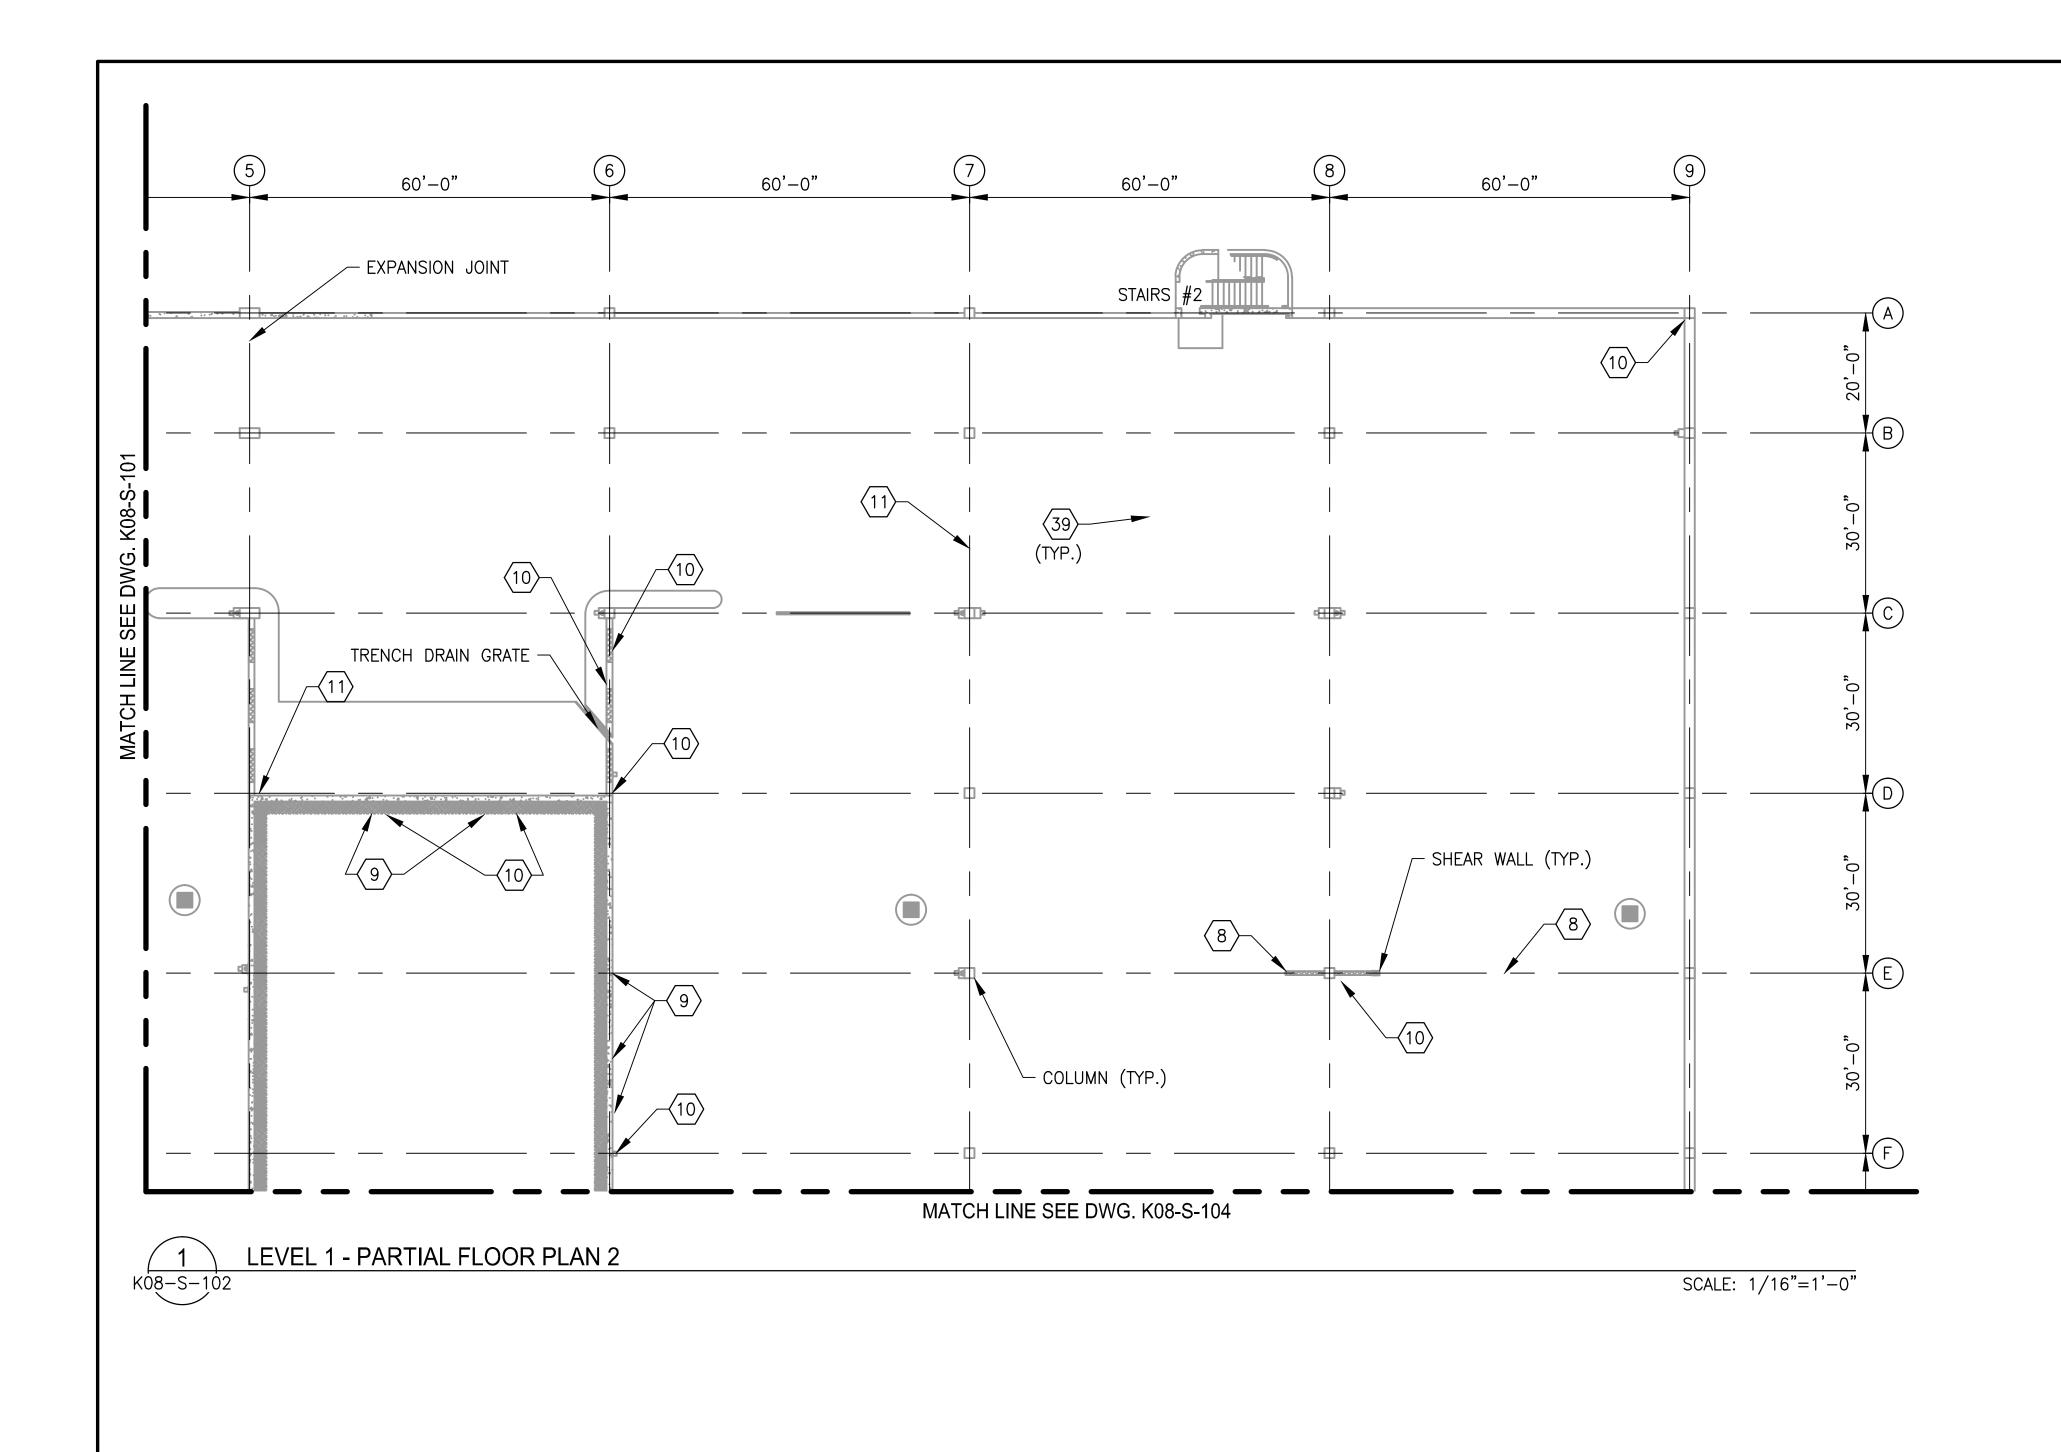

REVISIONS

DATE NUM


01/25/2018 0 FINAL SUBMITTAL

REFERENCE DRAWINGS

CHECKED D. SENGUPTA 01/2018
DATE

NOTES:


- 1. SEE DRAWING K08-S-002 FOR THE LIST OF KEY NOTES.
- 2. SILANE COATING SHALL BE PROVIDED FOR ENTIRE PARKING AREA.
- 3. SEE DRAWING K08-S-101 FOR REPAIR QUANTITY TABLE ON THIS LEVEL.

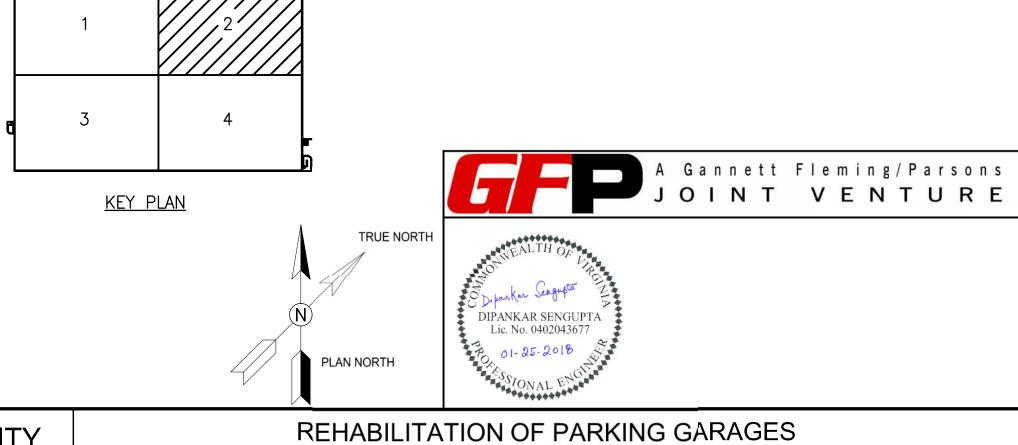



SHEET NO.

388 of 503

								<u> </u>				
SCRIPTION	WASHI	NGTON N	/IETROPOL	ITAN AREA TR	RANSIT AUTH	IORITY	REHABILITATION OF PARKING GARAGES K08 - VIENNA STATION - NORTH PARKING GARAGE					Ε
		OFFICE C		F OPERATING OF D FACILITIES	FFICER				PARTIA	LEVEL 1 L FLOOR PLAN 2		
	APPROVED JOHN PURDY ENGINEERING MANAGER		01/25/2018 DATE	APPROVED DIPANKAR SENGUPTA ENGINEER OF RECORI		01/25/2018 DATE	м NO. М1301	CONTRACT NO. FQ18064	SCALE 1/16"=1'-0"	DRAWING NO. K08-S-102	S	SHEET

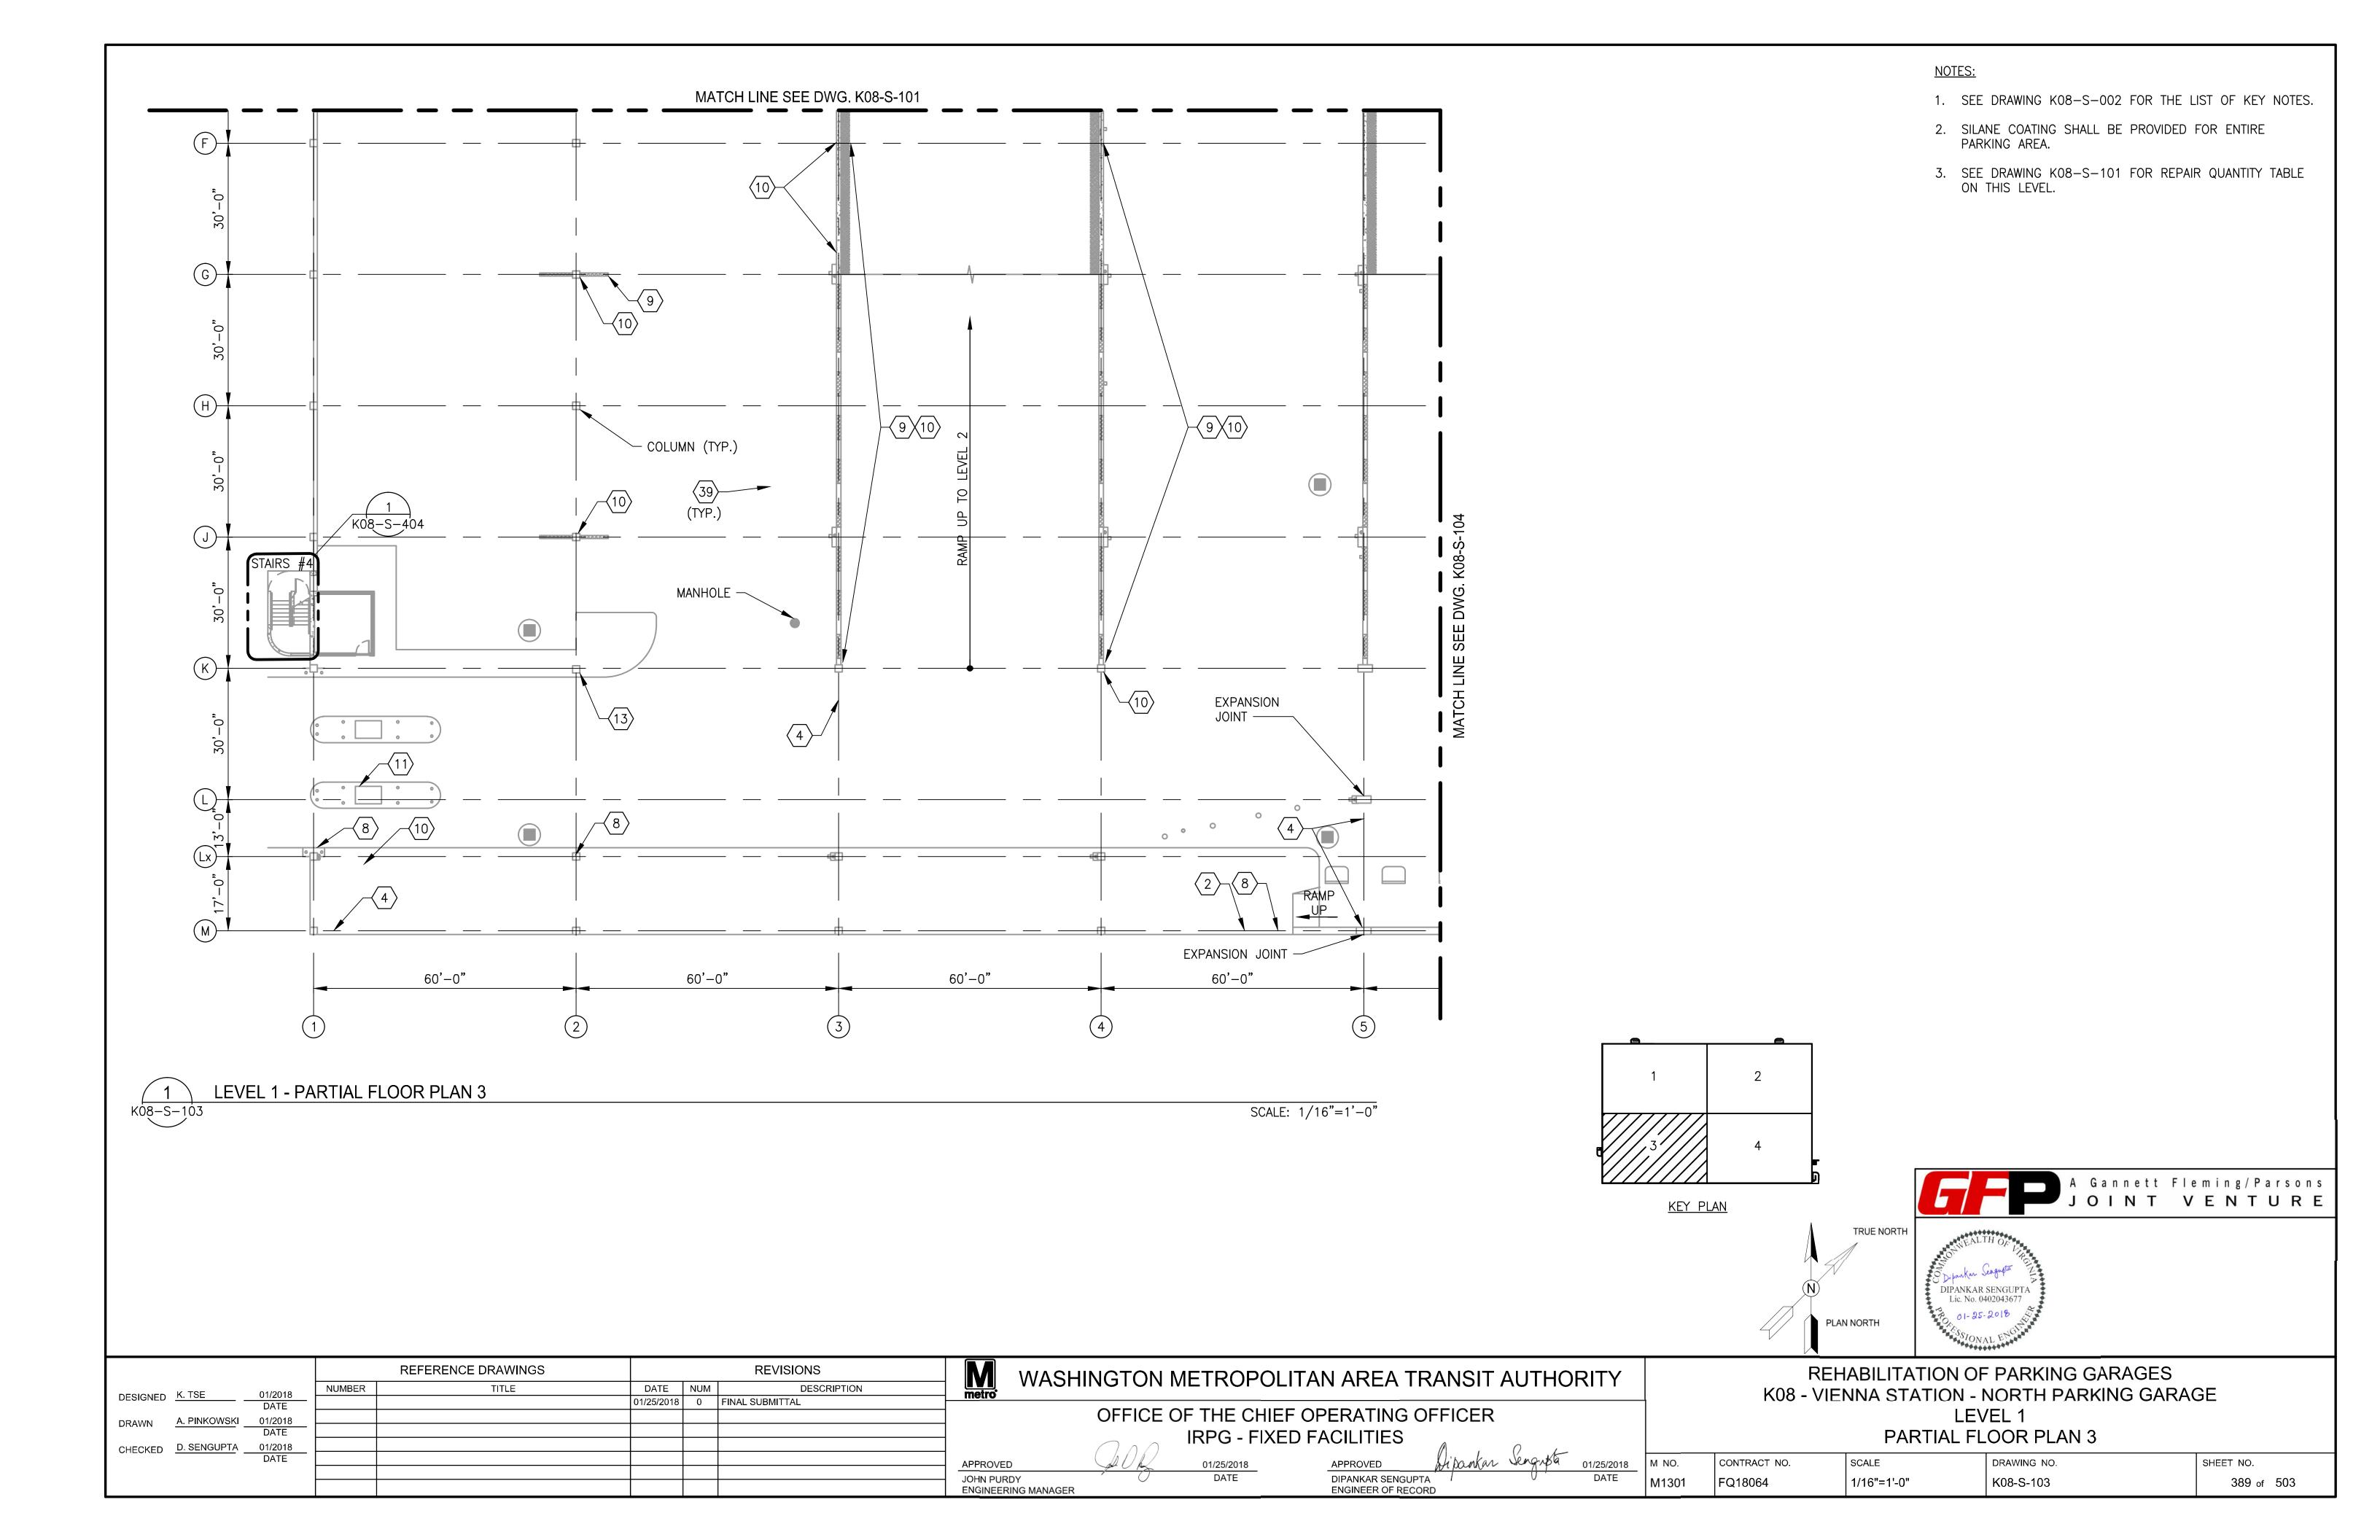

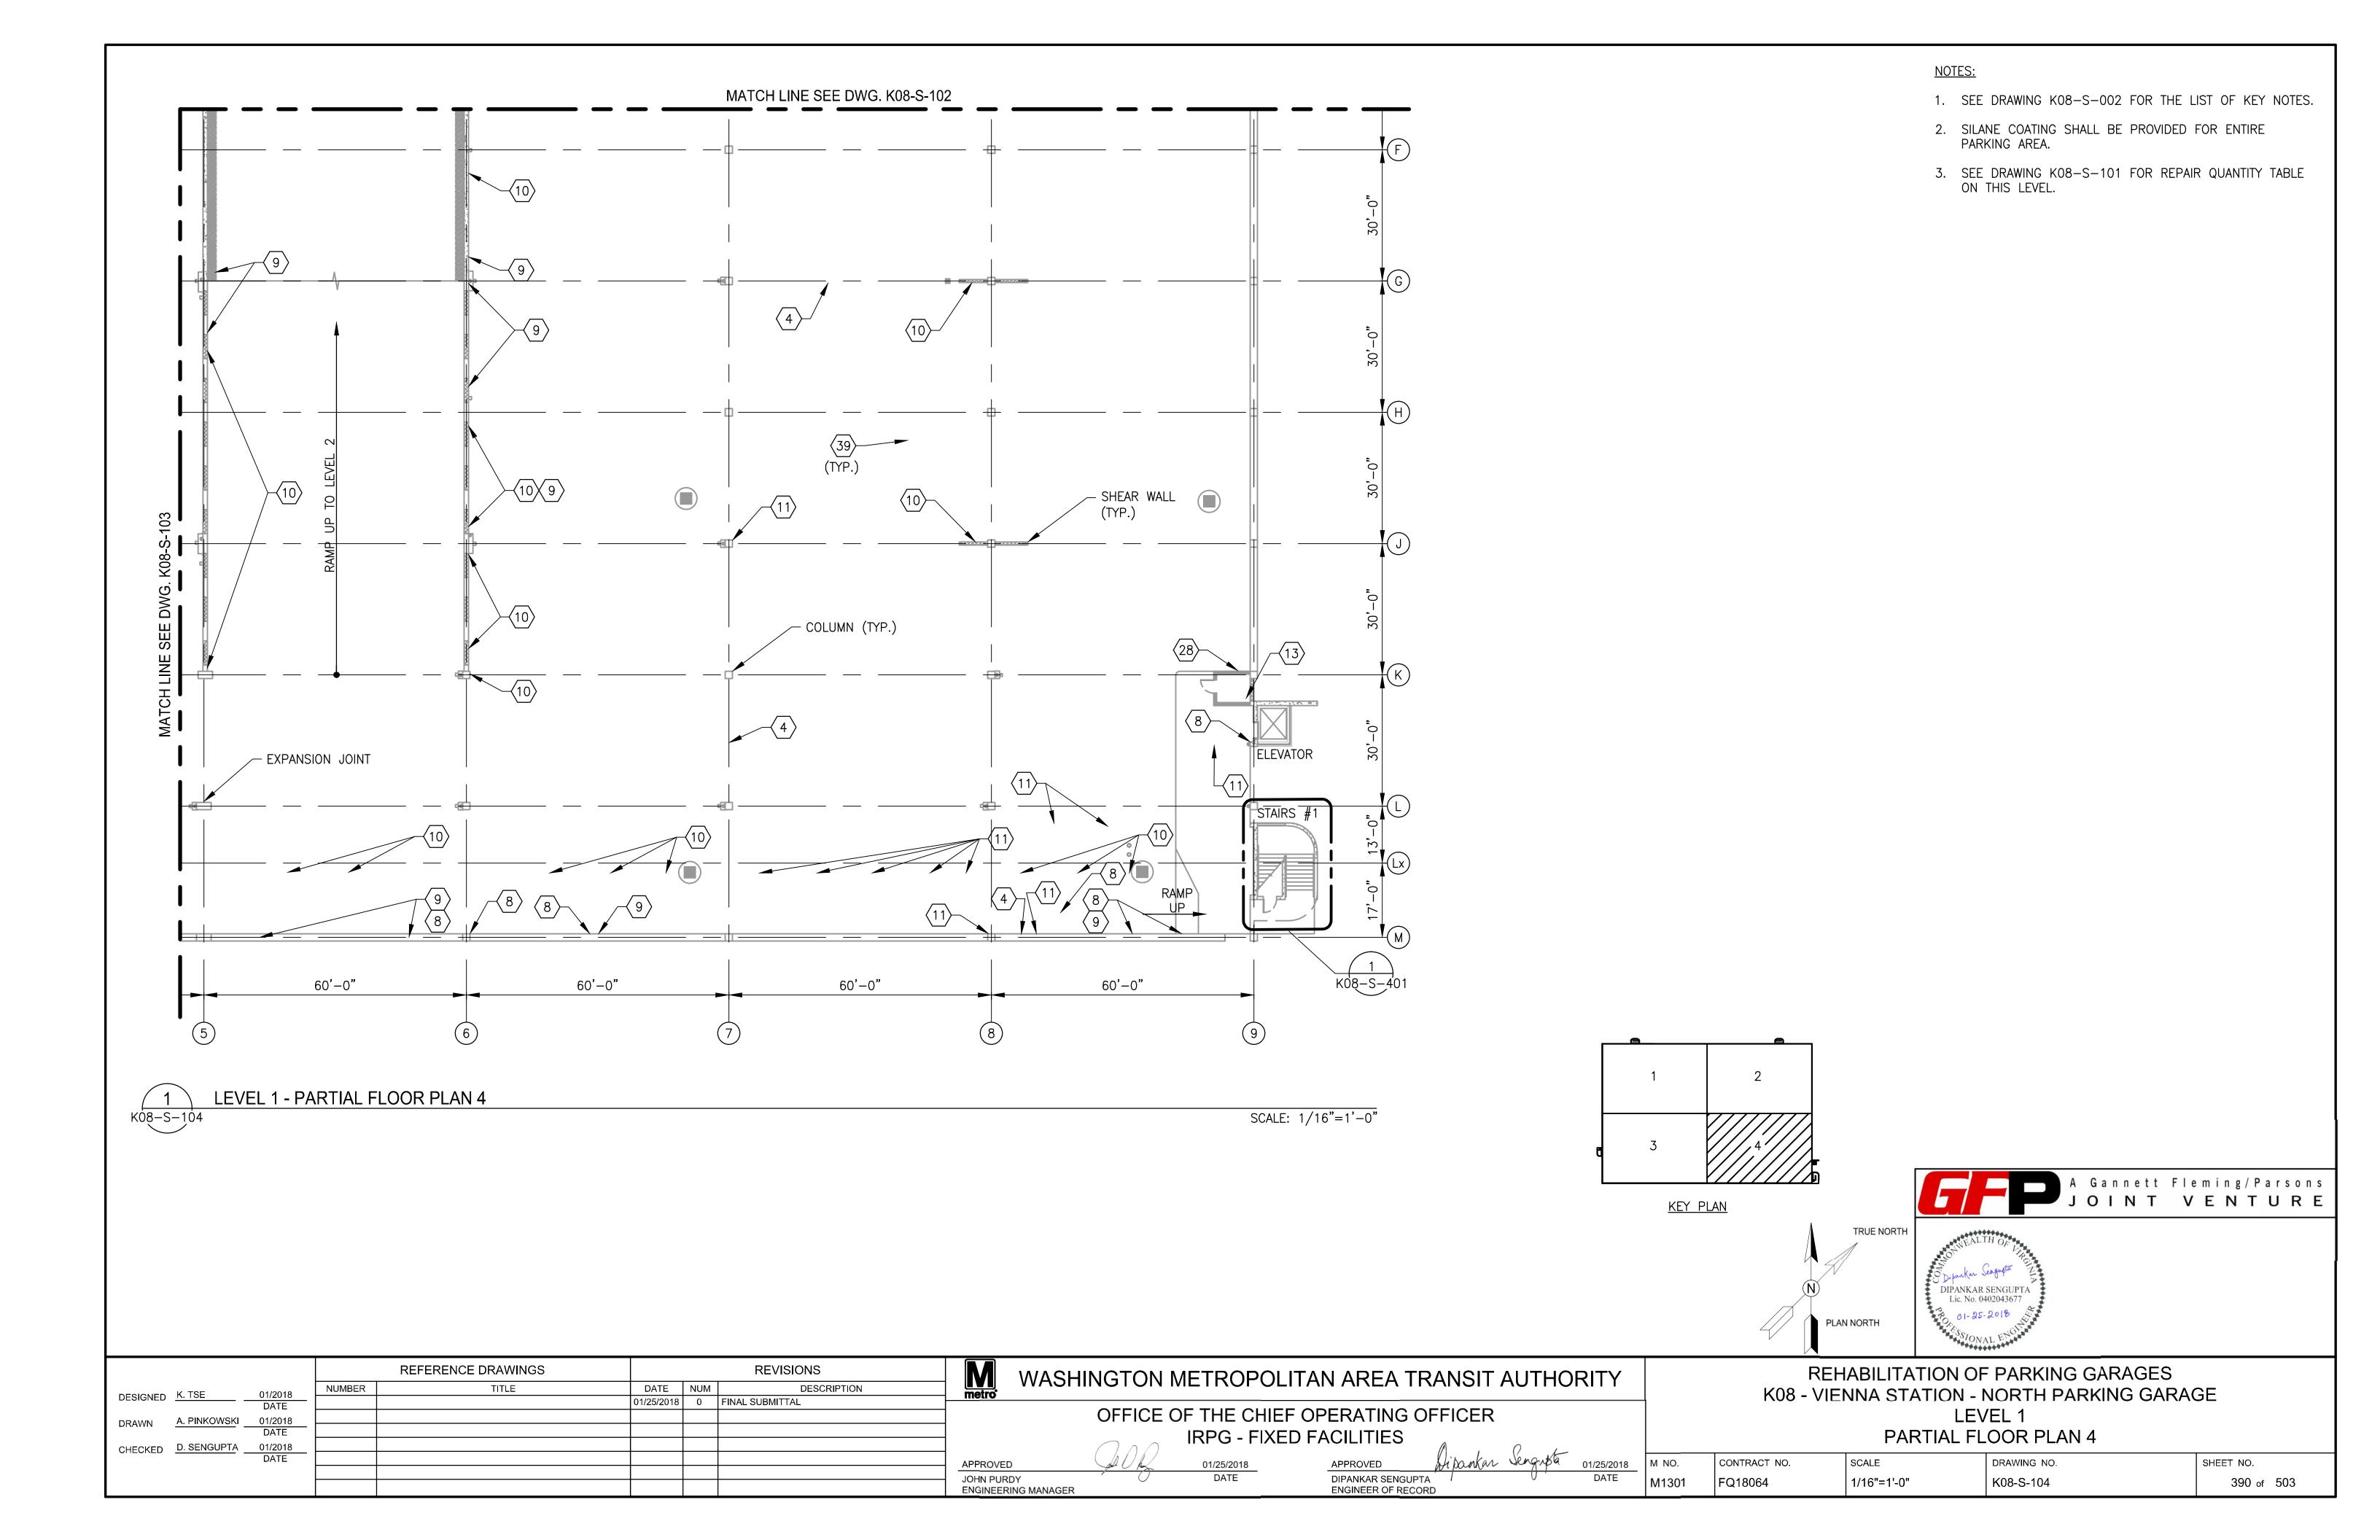

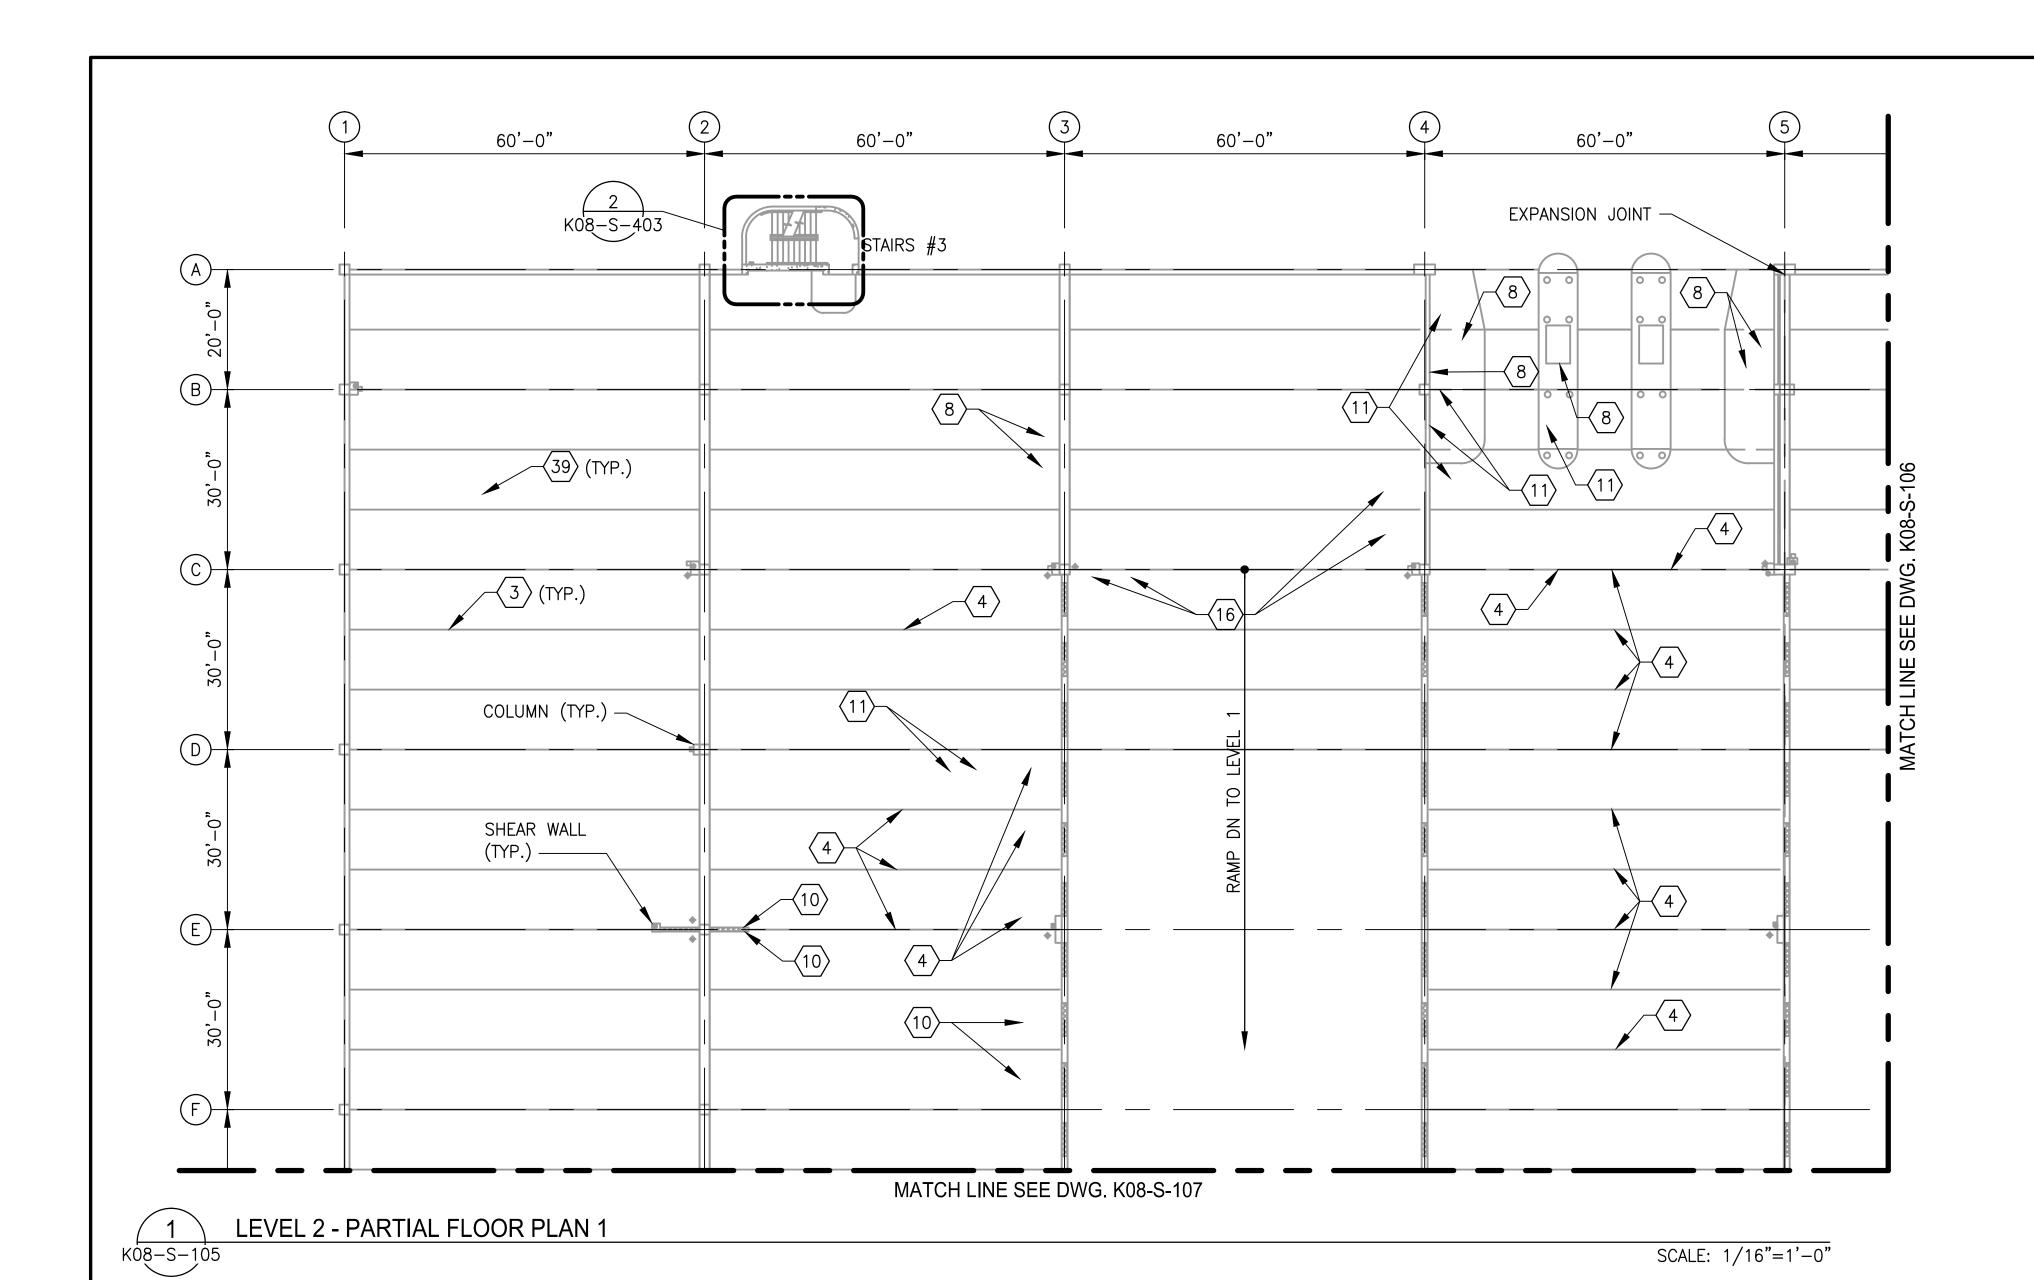

 STRUCTURAL REPAIR QUANTITIES (LEVEL 2)

 KEY NOTES
 QUANTITY
 UNIT OF QTY.
 NUMBER OF LOCATIONS

 1
 9
 LF
 1

 4
 385
 SF
 32

 8
 204
 LF
 17

 9
 42
 LF
 7

 10
 122
 SF
 16

 11
 70
 SF
 11

 16
 15
 SF
 1

 19
 39
 SF
 5

 26
 84
 SF
 2

 30
 3520
 SF
 2

 39
 142800
 SF
 1

TRUE NORTH

TRUE NORTH


PLAN NORTH

NOTES:


1. SEE DRAWING K08-S-002 FOR THE LIST OF KEY NOTES.

2. SILANE COATING SHALL BE PROVIDED FOR ENTIRE PARKING AREA.

	K TS	SE.	01/2018	NUMBER REFI	ERENCE DRAWINGS TITLE	DATE	NUM	REVISIONS DESCRIPTION		WASHINGTON METROPOLITAN AREA TRANSIT AUTHORITY						REHABILITATION OF PARKING GARAGES K08 - VIENNA STATION - NORTH PARKING GARAGE						
DES	IGNED K. TS	NKOWSKI	DATE 01/2018 DATE			01/25/2018	0 FINAL S	SUBMITTAL	metro	OFFICE OF THE CHIEF OPERATING OFFICER IRPG - FIXED FACILITIES						LEVEL 2 PARTIAL FLOOR PLAN 1						
СНЕ	CKED <u>D. SE</u>	ENGUPTA	l						APPROVED	Q OR	1RPG - FIX 01/25/2018	ED FACILITIES _APPROVED	Dipankar Sengupta on	/25/2018 M NO	CONTRACT NO.	SCALE	DRAWING NO.	SHEE	ET NO.			
			•						JOHN PURDY ENGINEERING MAN	IAGER	DATE	DIPANKAR SENGUPT ENGINEER OF RECO	.,,	DATE M130	1 FQ18064	1/16"=1'-0"	K08-S-105		391 of 503			

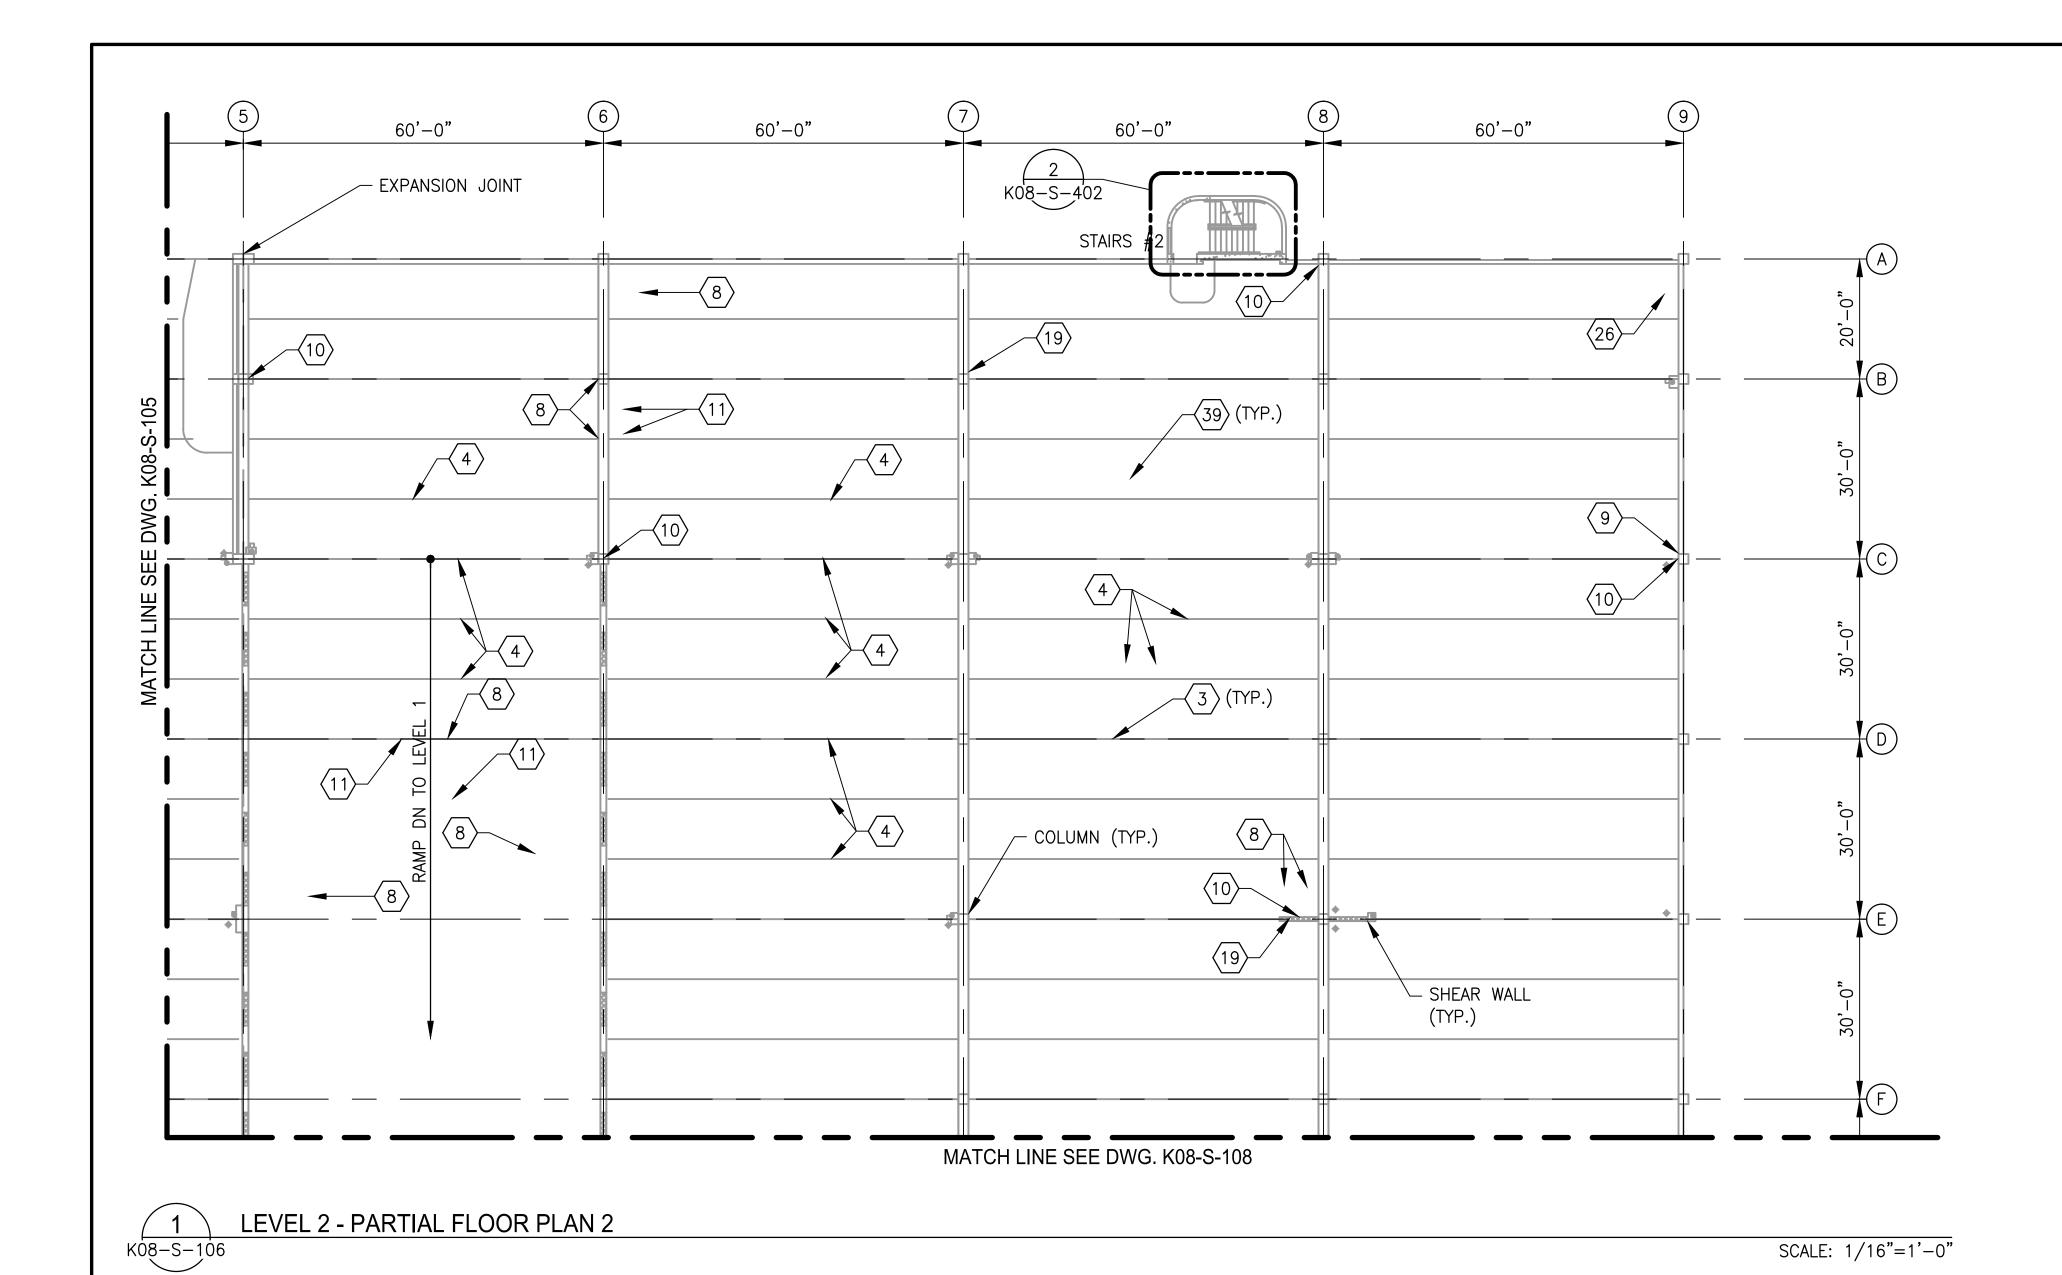

- 1. SEE DRAWING K08-S-002 FOR THE LIST OF KEY NOTES.
- 2. SILANE COATING SHALL BE PROVIDED FOR ENTIRE PARKING AREA.
- 3. SEE DRAWING K08-S-105 FOR REPAIR QUANTITY TABLE ON THIS LEVEL.

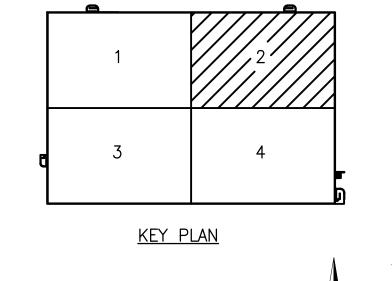

FQ18064



A Gannett Fleming/Parsons
JOINT VENTURE TRUE NORTH

				REFERENCE DRAWINGS			REVISIONS	M	V
5=01011=5	K. TSE	01/2018	NUMBER	TITLE	DATE	NUM	DESCRIPTION	metro	VV
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DIVAVVIV		DATE						1	
CHECKED	D. SENGUPTA	01/2018						1	
		DATE						APPROVED)
					İ			JOHN PURI	ז ע

WASHINGTON METROPOLITAN AREA TRANSIT AUTHORITY OFFICE OF THE CHIEF OPERATING OFFICER IRPG - FIXED FACILITIES 01/25/2018 DATE DIPANKAR SENGUPTA ENGINEER OF RECORD

ENGINEERING MANAGER


REHABILITATION OF PARKING GARAGES K08 - VIENNA STATION - NORTH PARKING GARAGE LEVEL 2 PARTIAL FLOOR PLAN 2


DRAWING NO. CONTRACT NO. SCALE


1/16"=1'-0"

PLAN NORTH

SHEET NO. K08-S-106 392 of 503

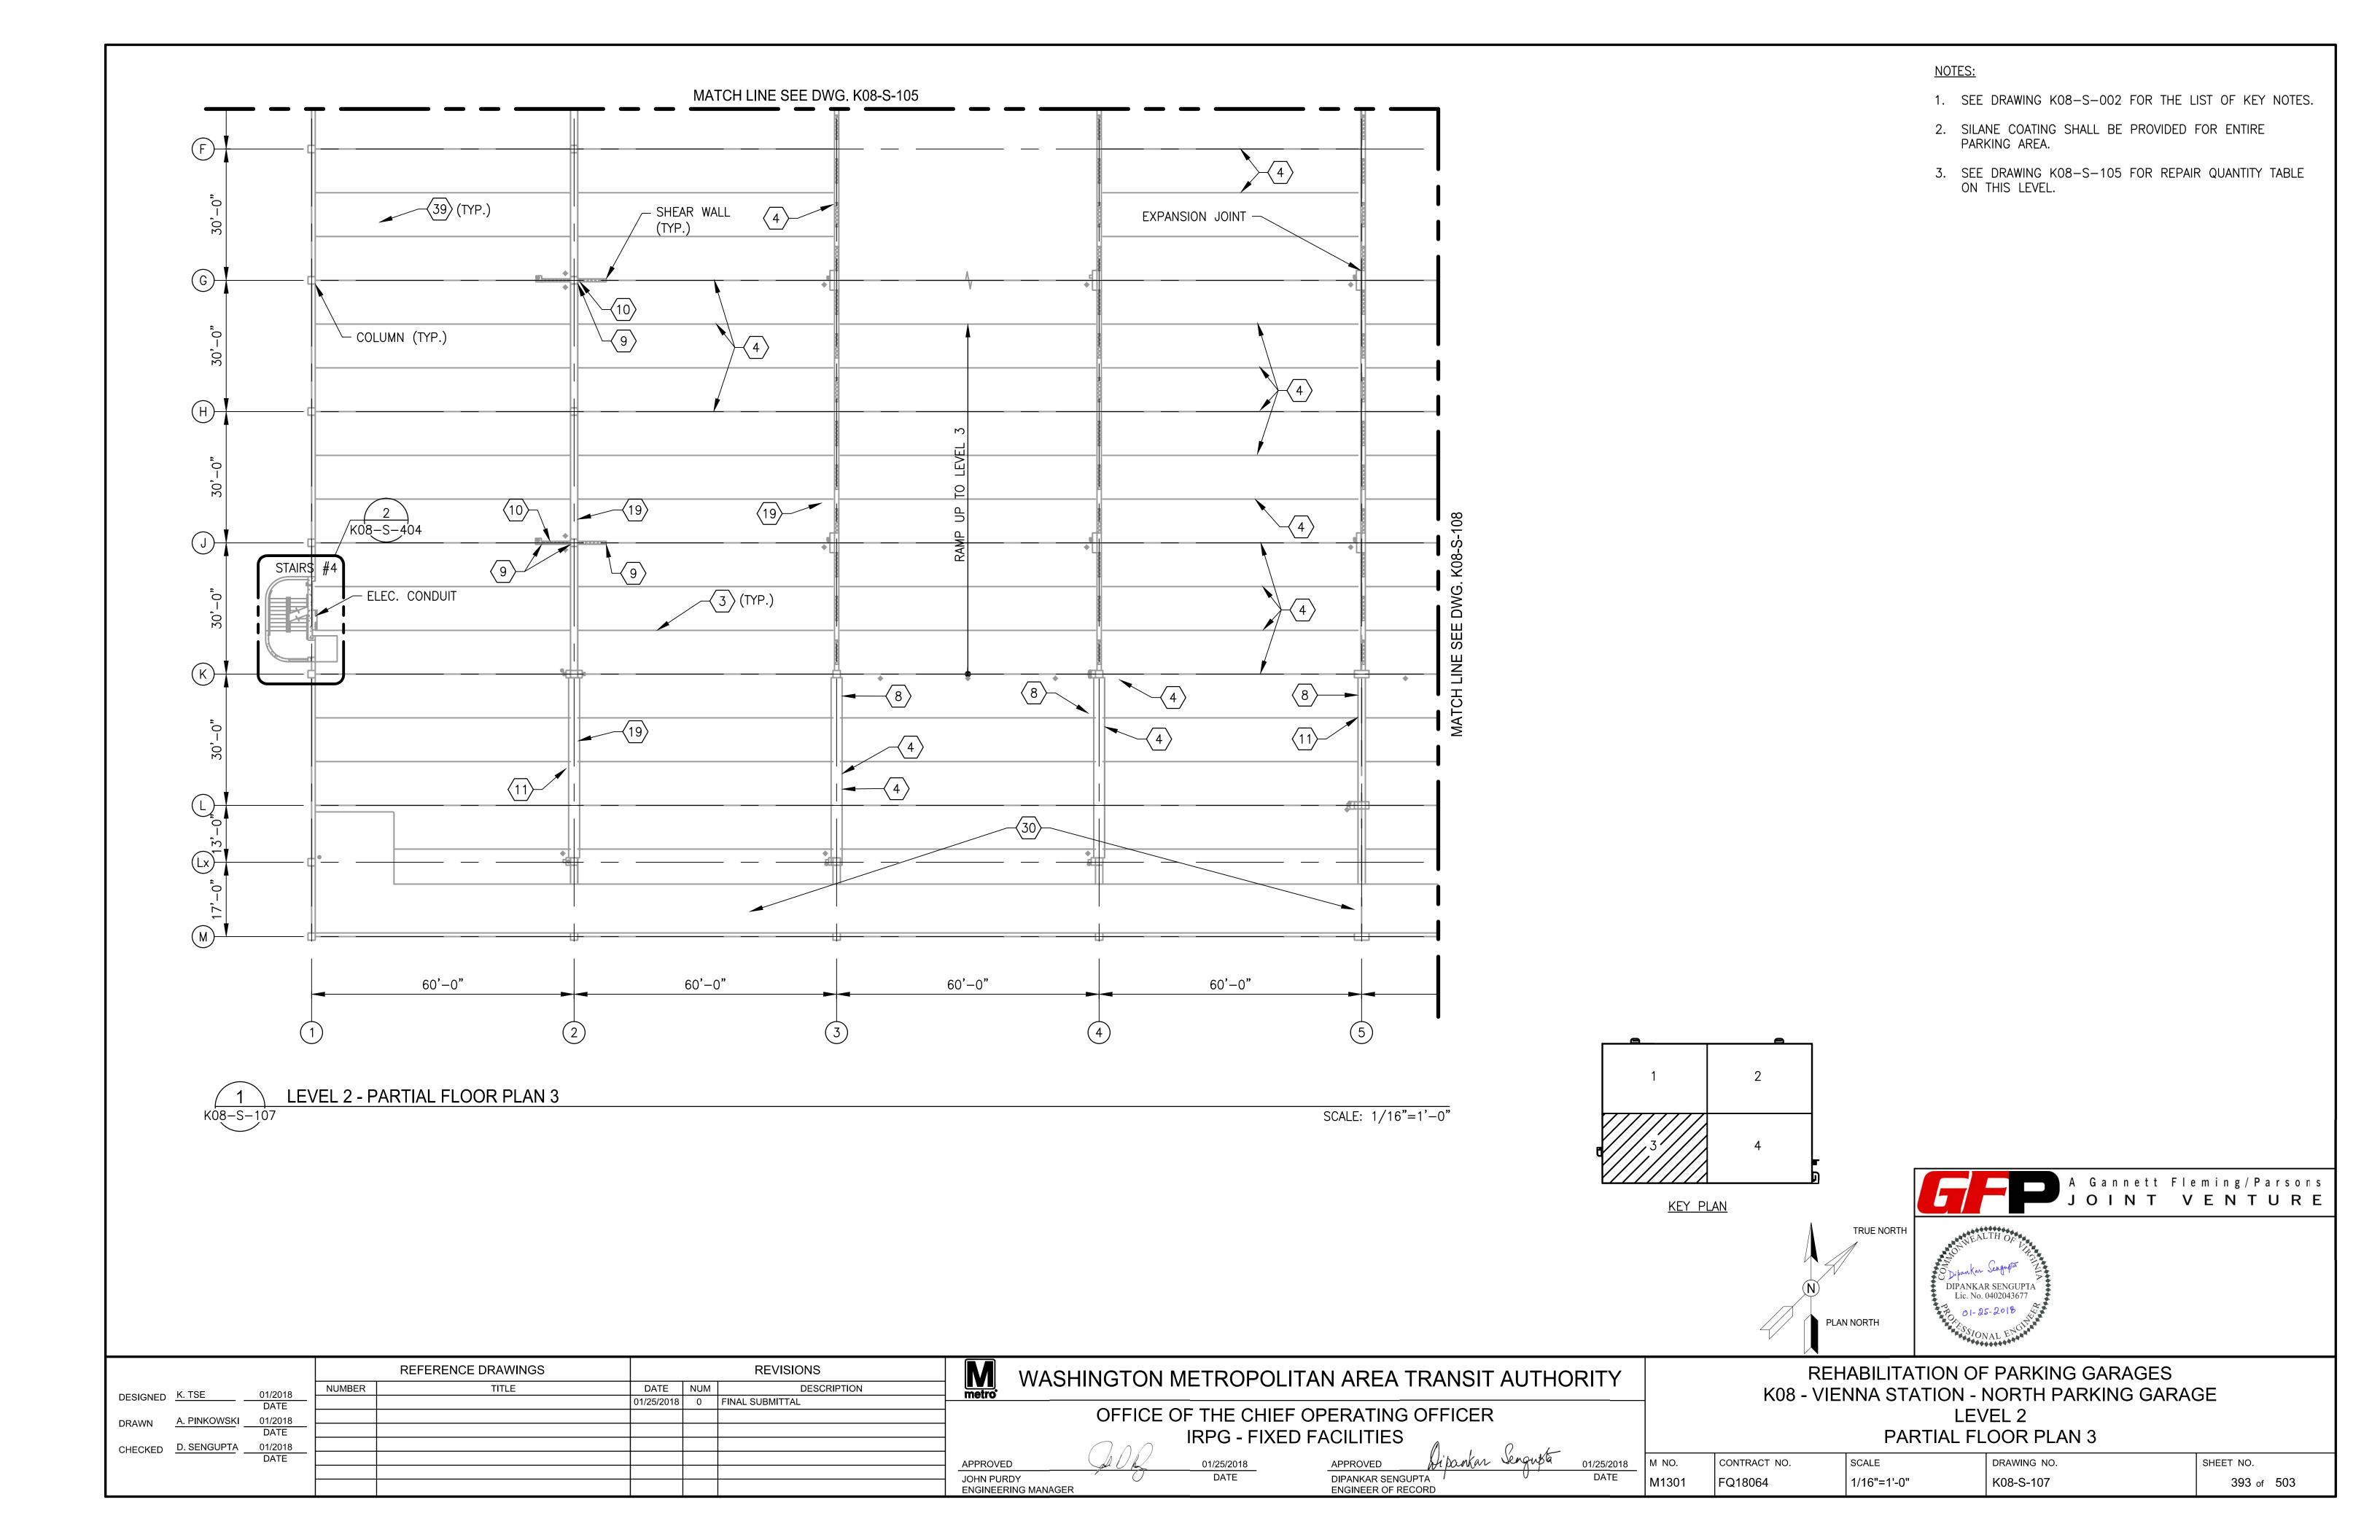

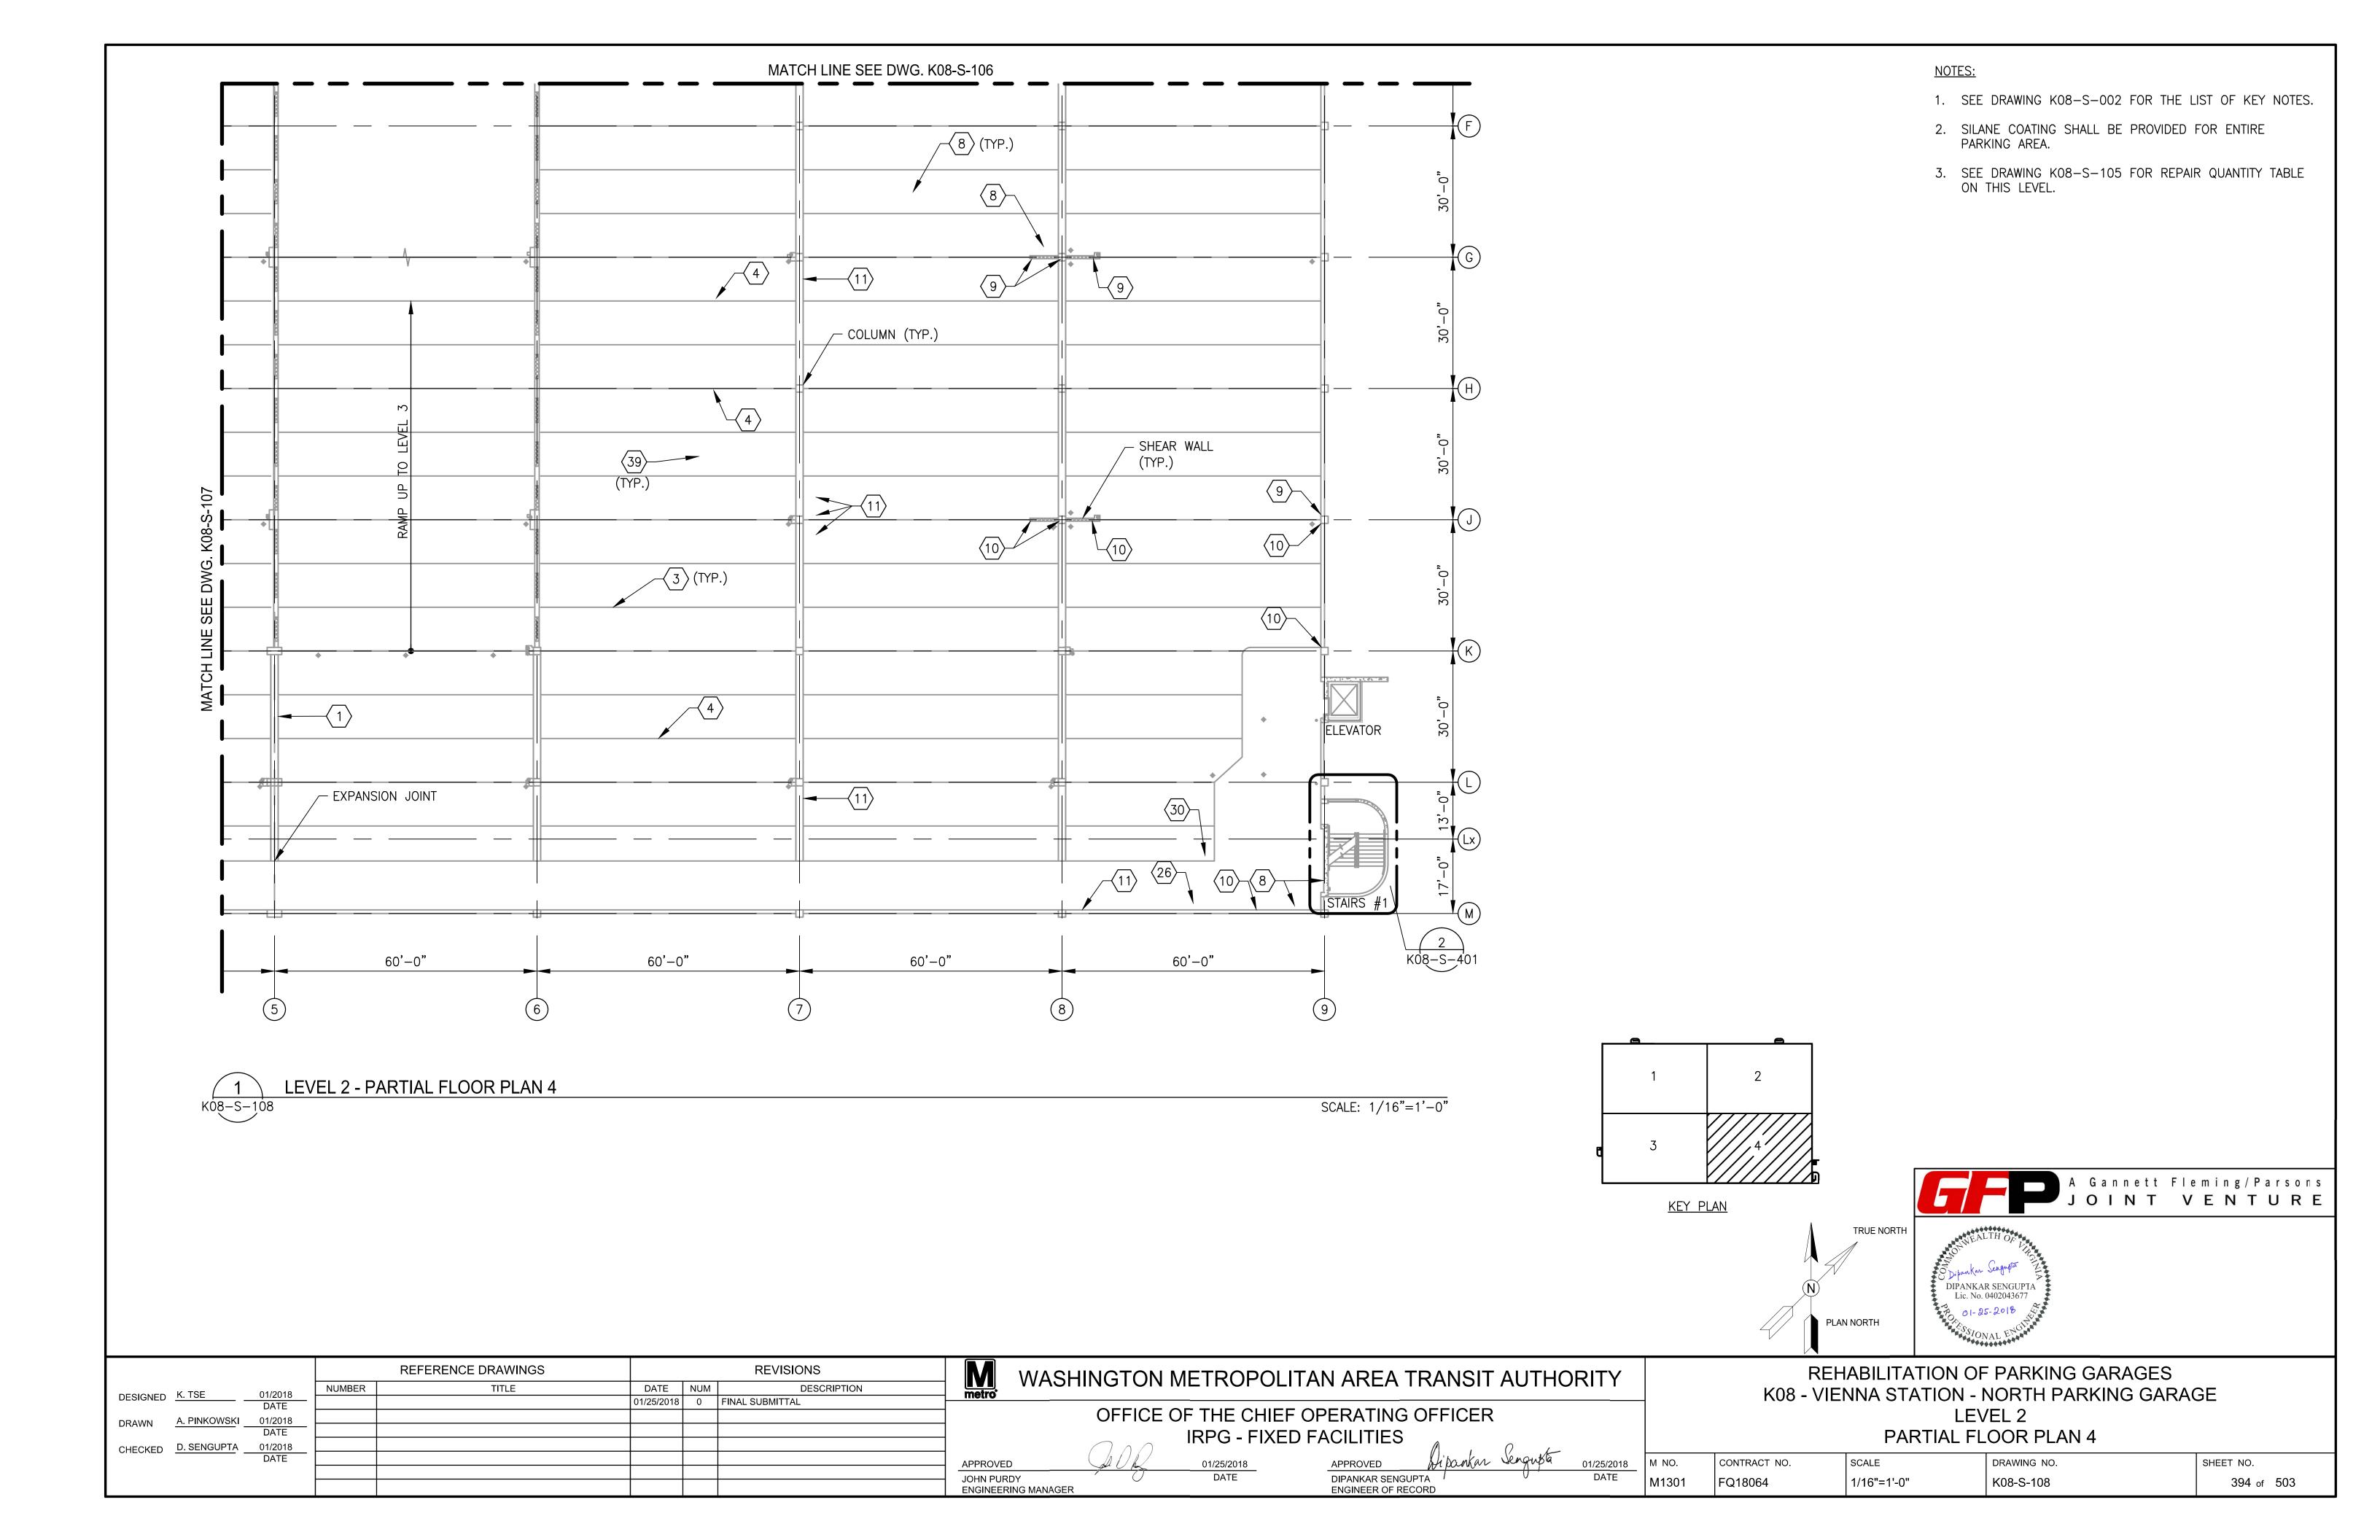

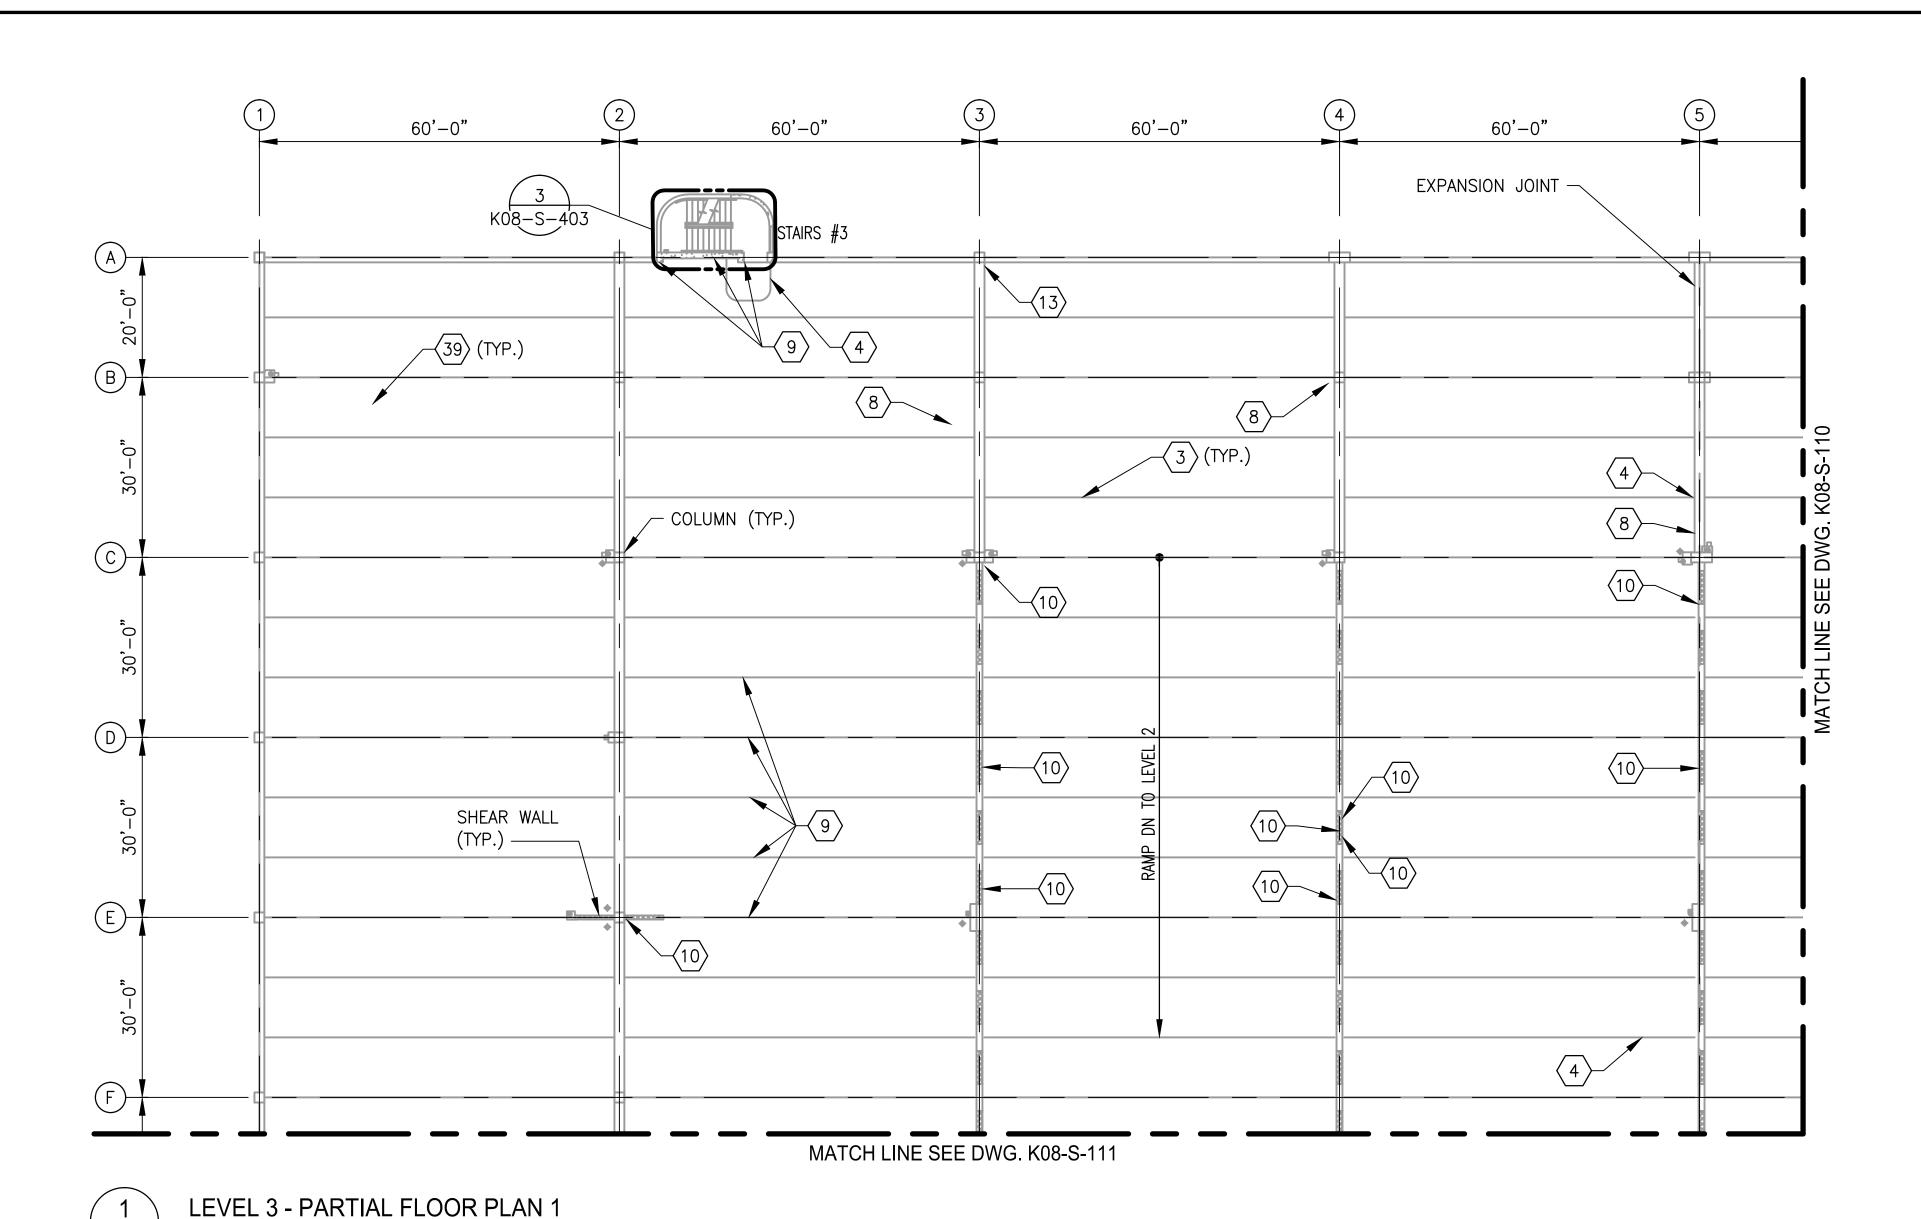

K08-S-109

SCALE: 1/16"=1'-0"

STRUCTURAL REPAIR QUANTITIES (LEVEL 3) KEY NOTES | QUANTITY | UNIT OF QTY. | NUMBER OF LOCATIONS 240 14400 3 ***** 107 12 378 11 3 9 21 39 10 168 SF 11 119 SF 14 13 3 SF SF 19 87 3 23 2400 1 151200 SF

* ALL EXISTING DOUBLE TEE BEAM JOINTS SHALL BE REPLACED WITH NEW JOINT.

A Gannett Fleming/Parsons JOINT VENTURE TRUE NORTH PLAN NORTH PLAN NORTH

NOTES:

PARKING AREA.

1. SEE DRAWING K08-S-002 FOR THE LIST OF KEY NOTES.


2. SILANE COATING SHALL BE PROVIDED FOR ENTIRE

		REFERENCE DRAWINGS			REVISIONS	Washington Metropolitan area transit authority	
DESIGNED <u>K. TSE</u> 01/2018	NUMBER	TITLE	DATE	NUM	DESCRIPTION	metro	
DATE DESIGNED			01/25/2018	0	FINAL SUBMITTAL		
DRAWN A. PINKOWSKI 01/2018						OFFICE OF THE CHIEF OPERATING OFFICER	
DATE						IRPG - FIXED FACILITIES	
CHECKED D. SENGUPTA 01/2018							
DATE				<u> </u>		APPROVED APPROVED Shi bankar Jengusta 01/25/2018 M N	NO.
						JOHN PURDY DATE DIPANKAR SENGUPTA DATE M11	1301
						FNGINEERING MANAGER FNGINEER OF RECORD	1301


REHABILITATION OF PARKING GARAGES K08 - VIENNA STATION - NORTH PARKING GARAGE LEVEL 3 PARTIAL FLOOR PLAN 1

D. CONTRACT NO. SCALE DRAWING NO. 1/16"=1'-0" K08-S-109


DRAWING NO. SHEET NO. 395 of 503

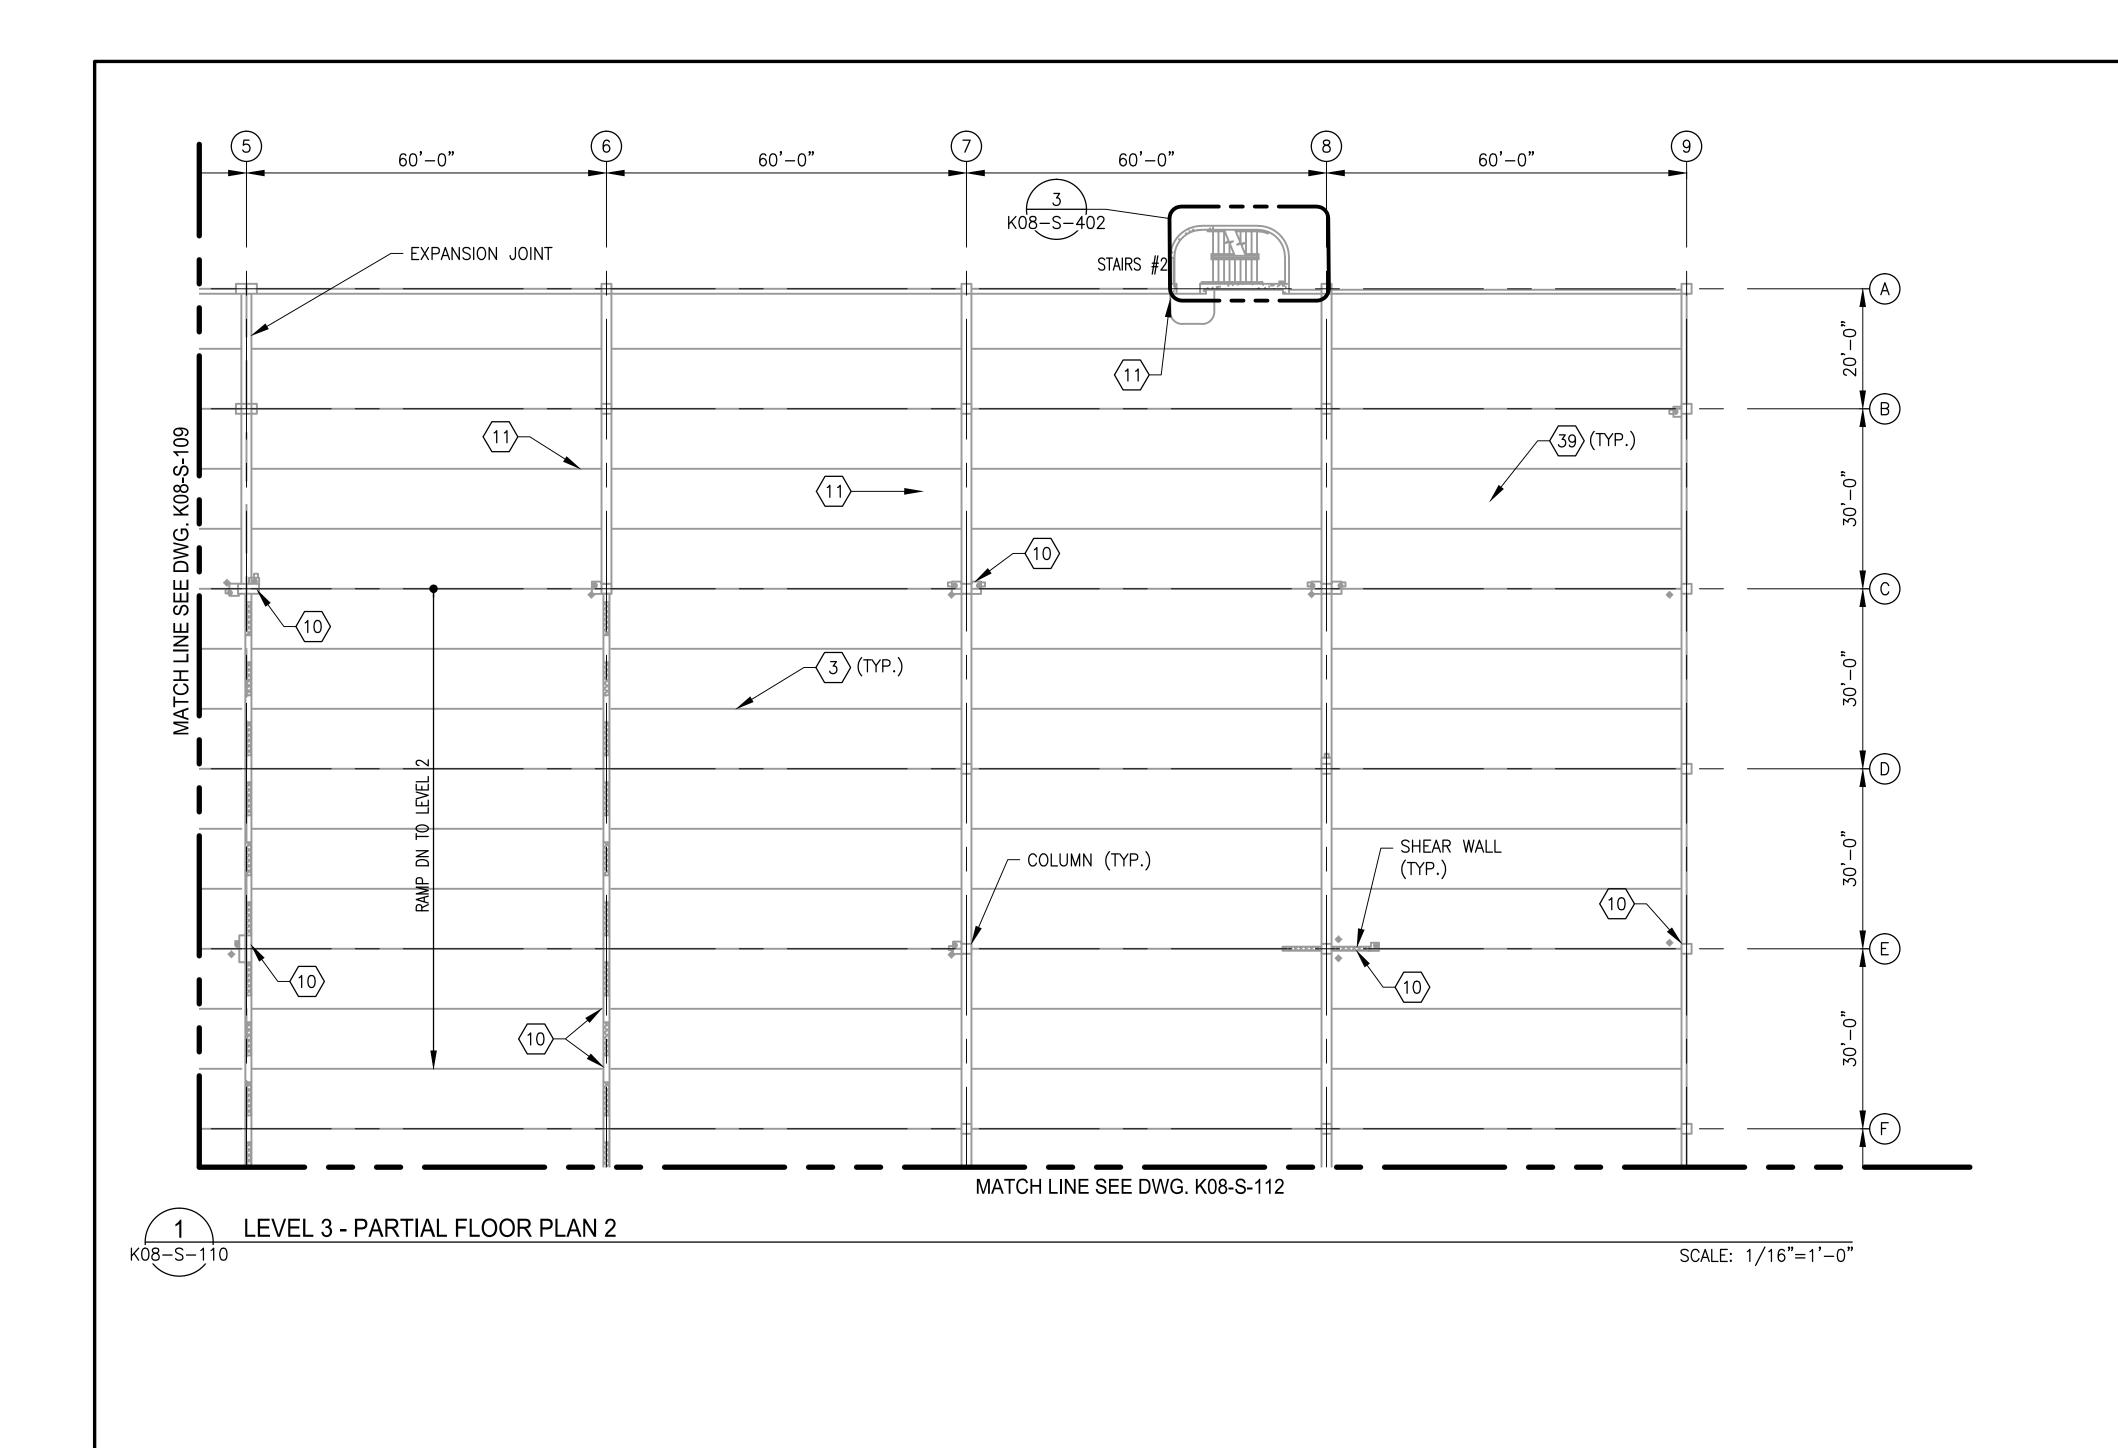



- 1. SEE DRAWING K08-S-002 FOR THE LIST OF KEY NOTES.
- SILANE COATING SHALL BE PROVIDED FOR ENTIRE PARKING AREA.
- 3. SEE DRAWING K08-S-109 FOR REPAIR QUANTITY TABLE ON THIS LEVEL.

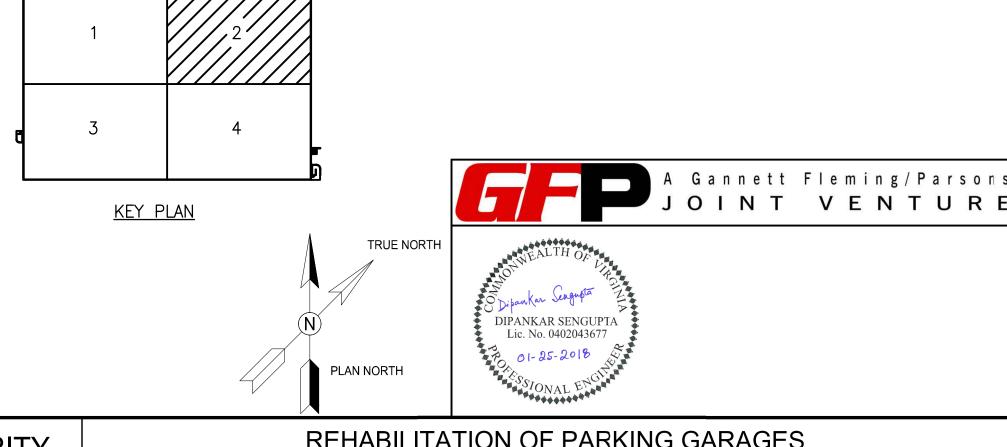

K TOE	04/2049	NUMBER	REFERENCE DRAWINGS TITLE	DATE	R	REVISIONS DESCRIPTION	WASHINGTON METROPOLITAN AREA TRANSIT AUTHORITY		REHABILITATION OF PARKING GARAGES K08 - VIENNA STATION - NORTH PARKING GARAGE							
DRAWN A. PINKOWSKI	01/2018 DATE 01/2018 DATE 01/2018			01/25/2018	0 FINAL SU	JBMITTAL	metro	OFFICE C		F OPERATING C D FACILITIES	OFFICER		NU8 -	L	- NORTH PARKIN EVEL 3 FLOOR PLAN 2	G GARAGE
CHECKED <u>B. SENGOLIA</u>	DATE						APPROVED JOHN PURDY ENGINEERING MANAGER		01/25/2018 DATE	APPROVED DIPANKAR SENGUPT ENGINEER OF RECO			CONTRACT NO. FQ18064	SCALE 1/16"=1'-0"	DRAWING NO. K08-S-110	SHEET NO. 396 of 503

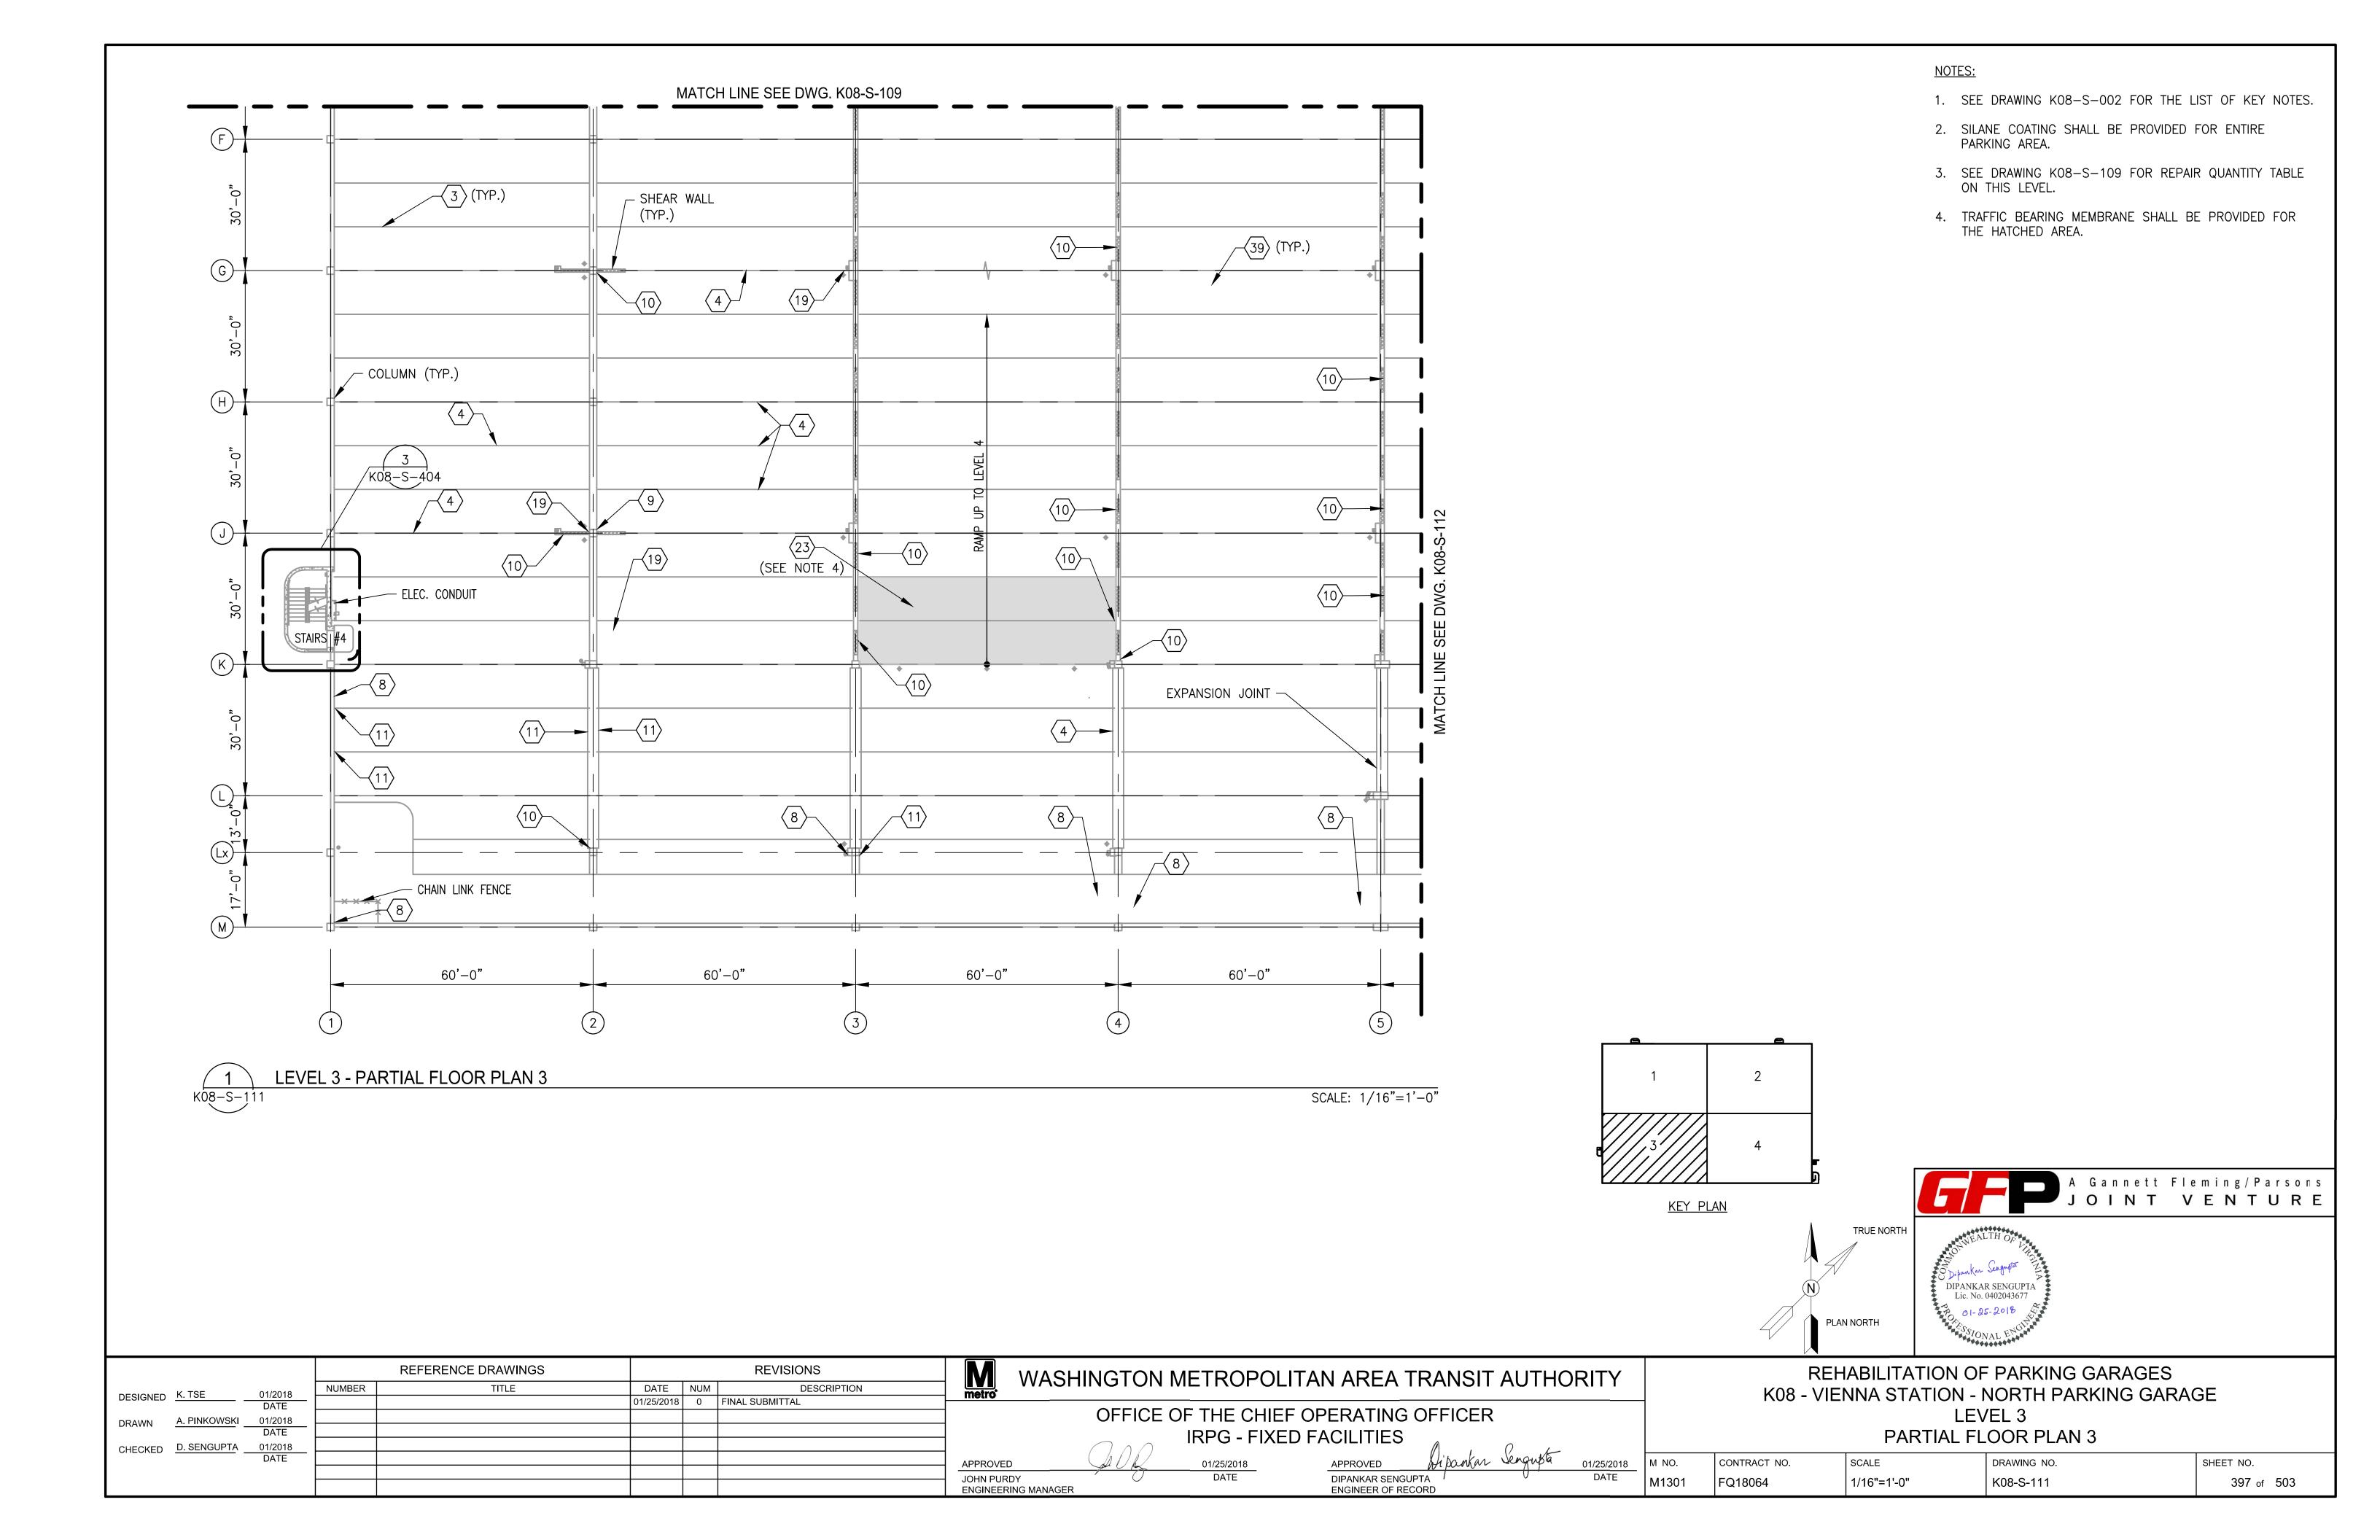

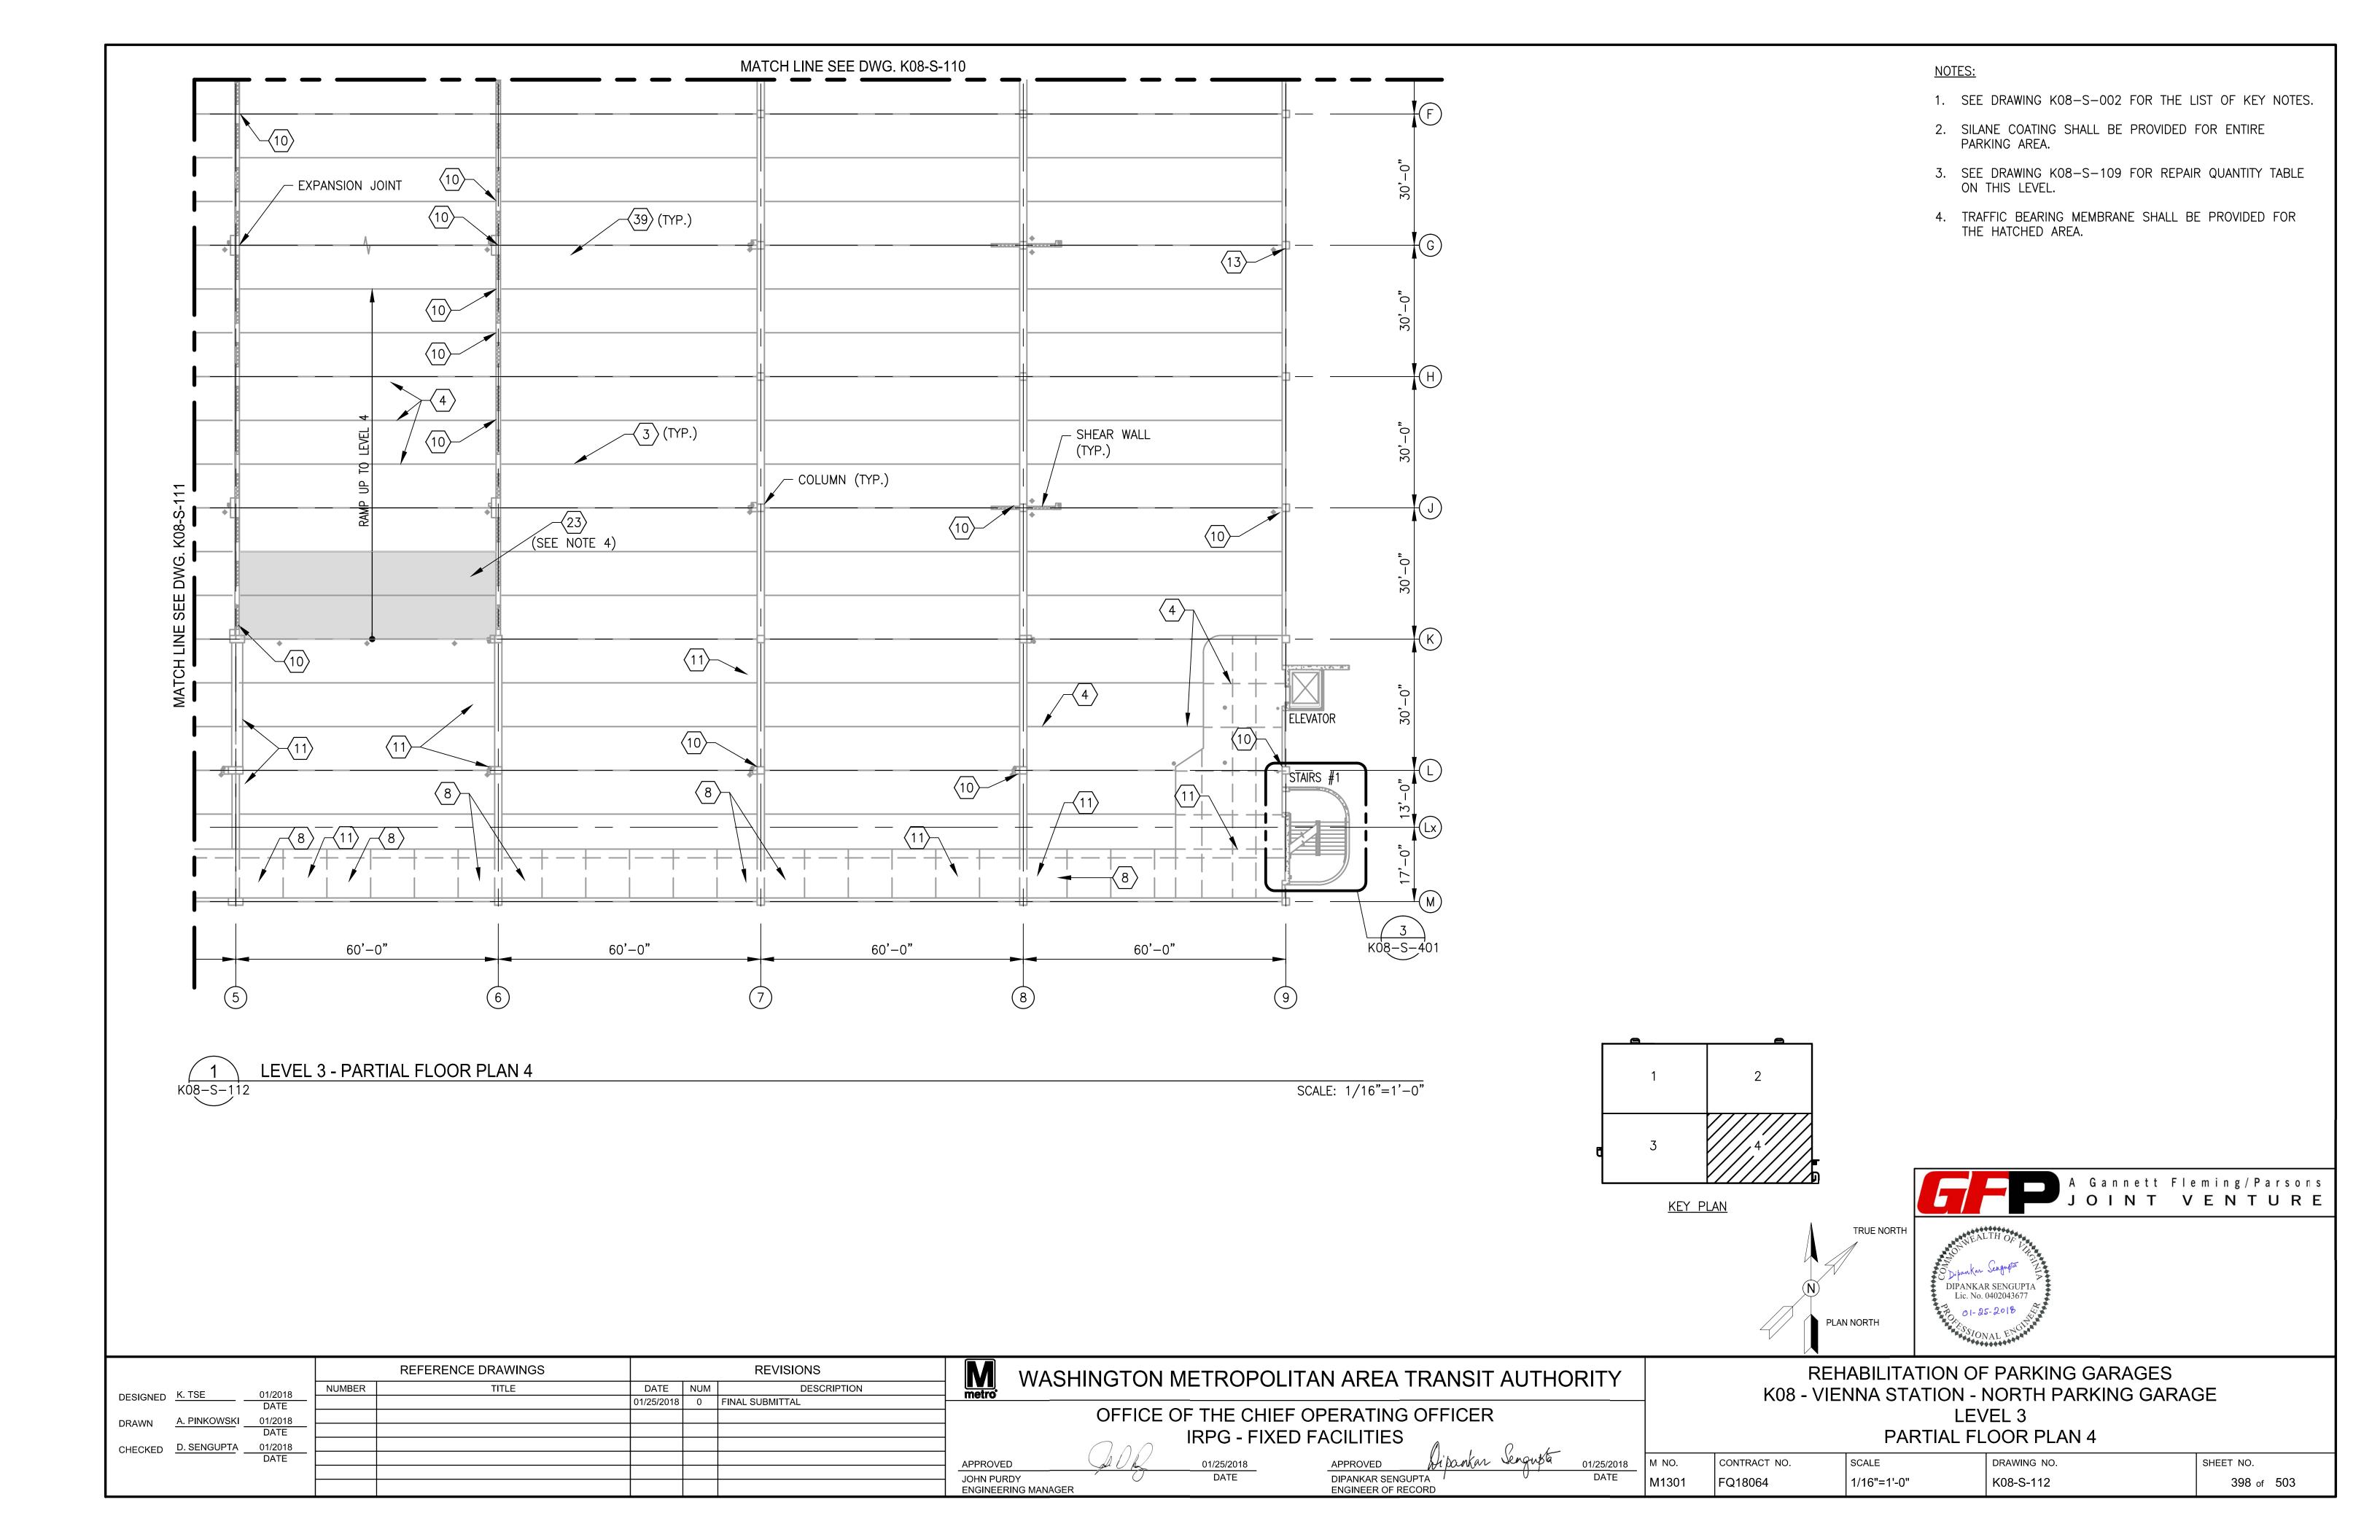

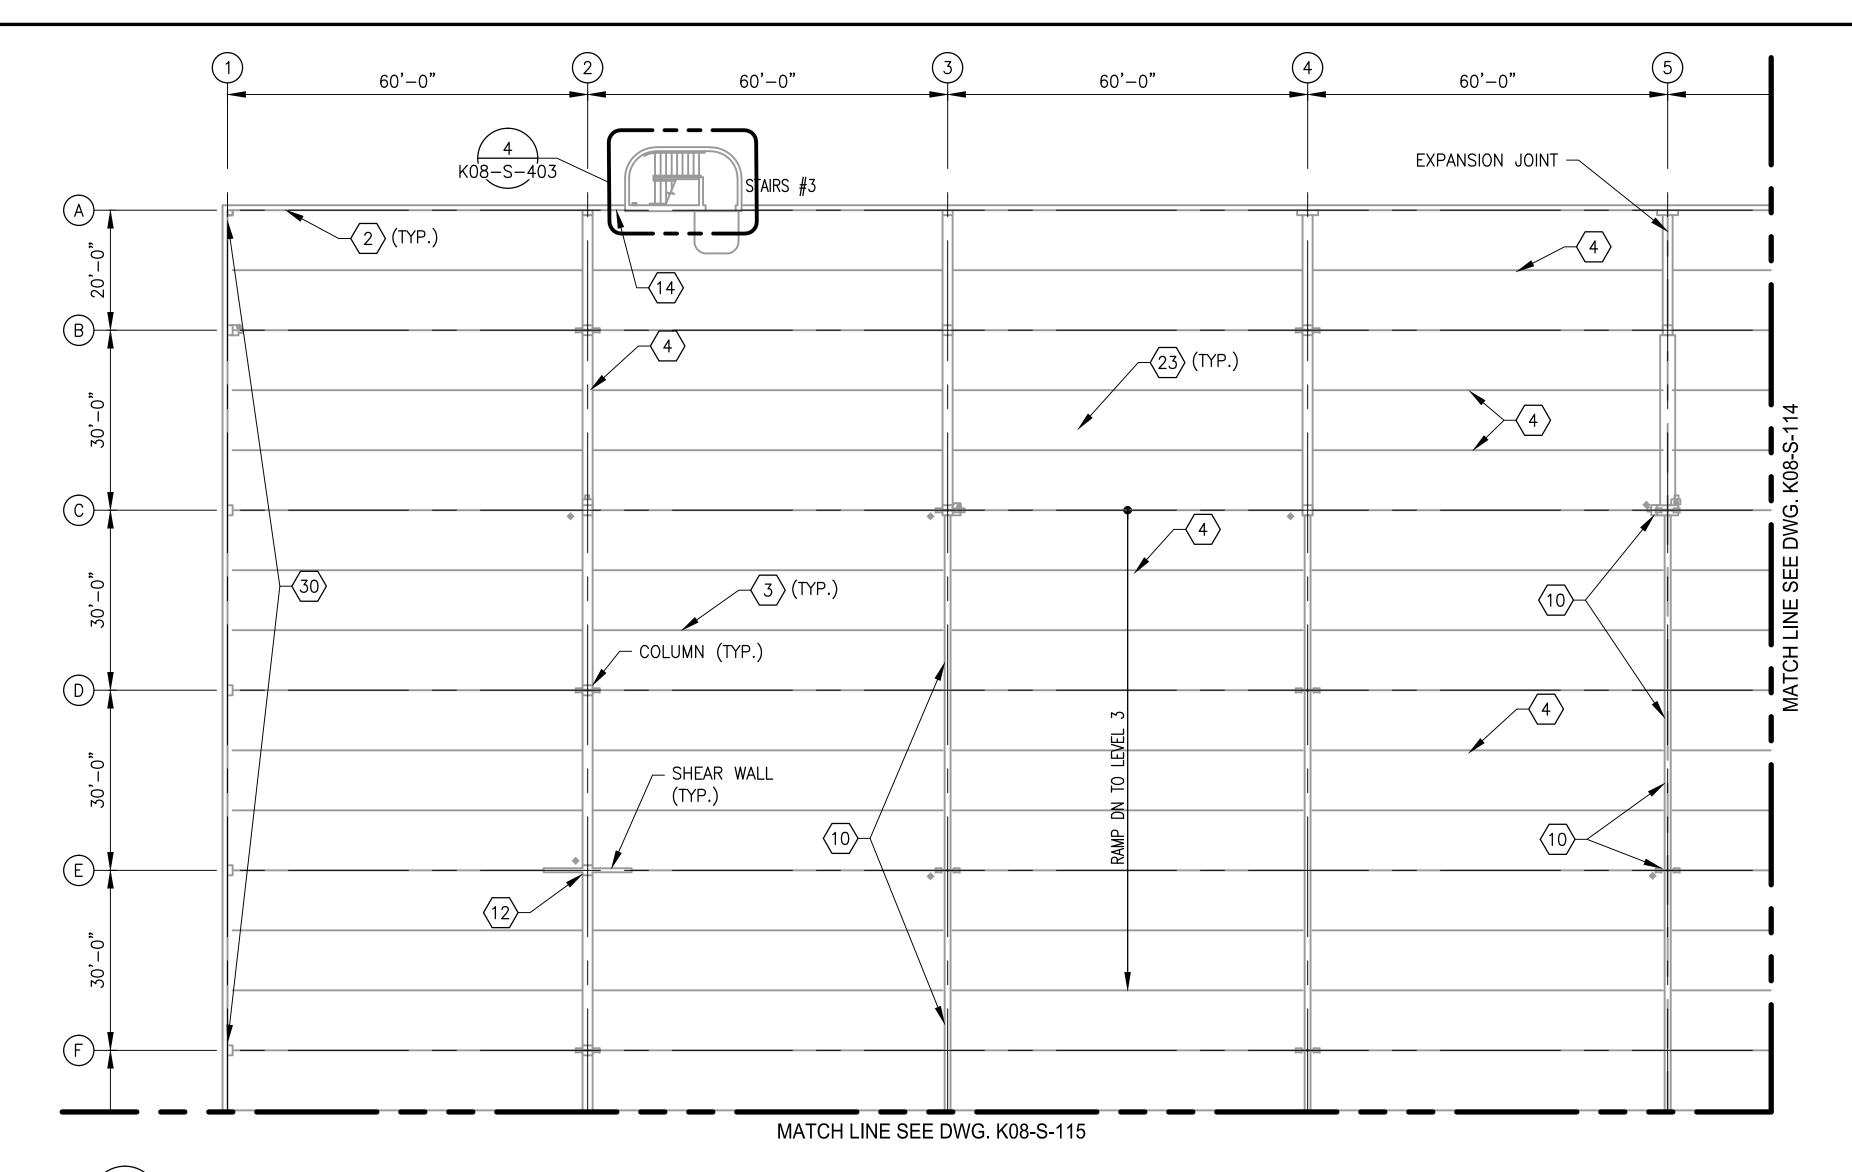

LEVEL 4 - PARTIAL FLOOR PLAN 1

SCALE: 1/16"=1'-0"

STRUCTURAL REPAIR QUANTITIES (LEVEL 4)									
KEY NOTES	QUANTITY	UNIT OF QTY.	NUMBER OF LOCATIONS						
1	13	LF	1						
2**	6720	LF	40						
3*	14400	LF	240						
4	372	SF	49						
10	136	SF	43						
11	179	SF	15						
12	59	SF	6						
14	2	EA	2						
17	21	SF	3						
20	96	SF	2						
23	153600	SF	1						
30	1500	SF	1						

* ALL EXISTING DOUBLE TEE BEAM JOINTS SHALL BE REPLACED WITH NEW JOINT.

** ALL EXISTING TOOL JOINTS AT ROOF LEVEL SHALL BE REPLACED WITH NEW JOINT.

			REFERENCE DRAWINGS			REVISIONS	M metro ∨	VASHI
DESIGNED K. TSE	01/2018	NUMBER	TITLE	DATE	NUM	DESCRIPTION	metro V	
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DRAWN A. PINKOWSKI	01/2018							
	DATE							
CHECKED D. SENGUPTA	01/2018							
	DATE						APPROVED	
							JOHN PURDY	
							ENGINEERING	MANAGER

WASHINGTON METROPOLITAN AREA TRANSIT AUTHORITY OFFICE OF THE CHIEF OPERATING OFFICER IRPG - FIXED FACILITIES 01/25/2018 DATE

DIPANKAR SENGUPTA ENGINEER OF RECORD

REHABILITATION OF PARKING GARAGES K08 - VIENNA STATION - NORTH PARKING GARAGE LEVEL 4 PARTIAL FLOOR PLAN 1

NOTES:

ENTIRE PARKING AREA.

1. SEE DRAWING K08-S-002 FOR THE LIST OF KEY NOTES.

2. TRAFFIC BEARING MEMBRANE SHALL BE PROVIDED FOR


CONTRACT NO. SCALE DRAWING NO.

1/16"=1'-0"


FQ18064


SHEET NO. K08-S-113 399 of 503


A Gannett Fleming/Parsons
JOINT VENTURE KEY PLAN TRUE NORTH DIPANKAR SENGUPTA Lic. No. 0402043677 PLAN NORTH

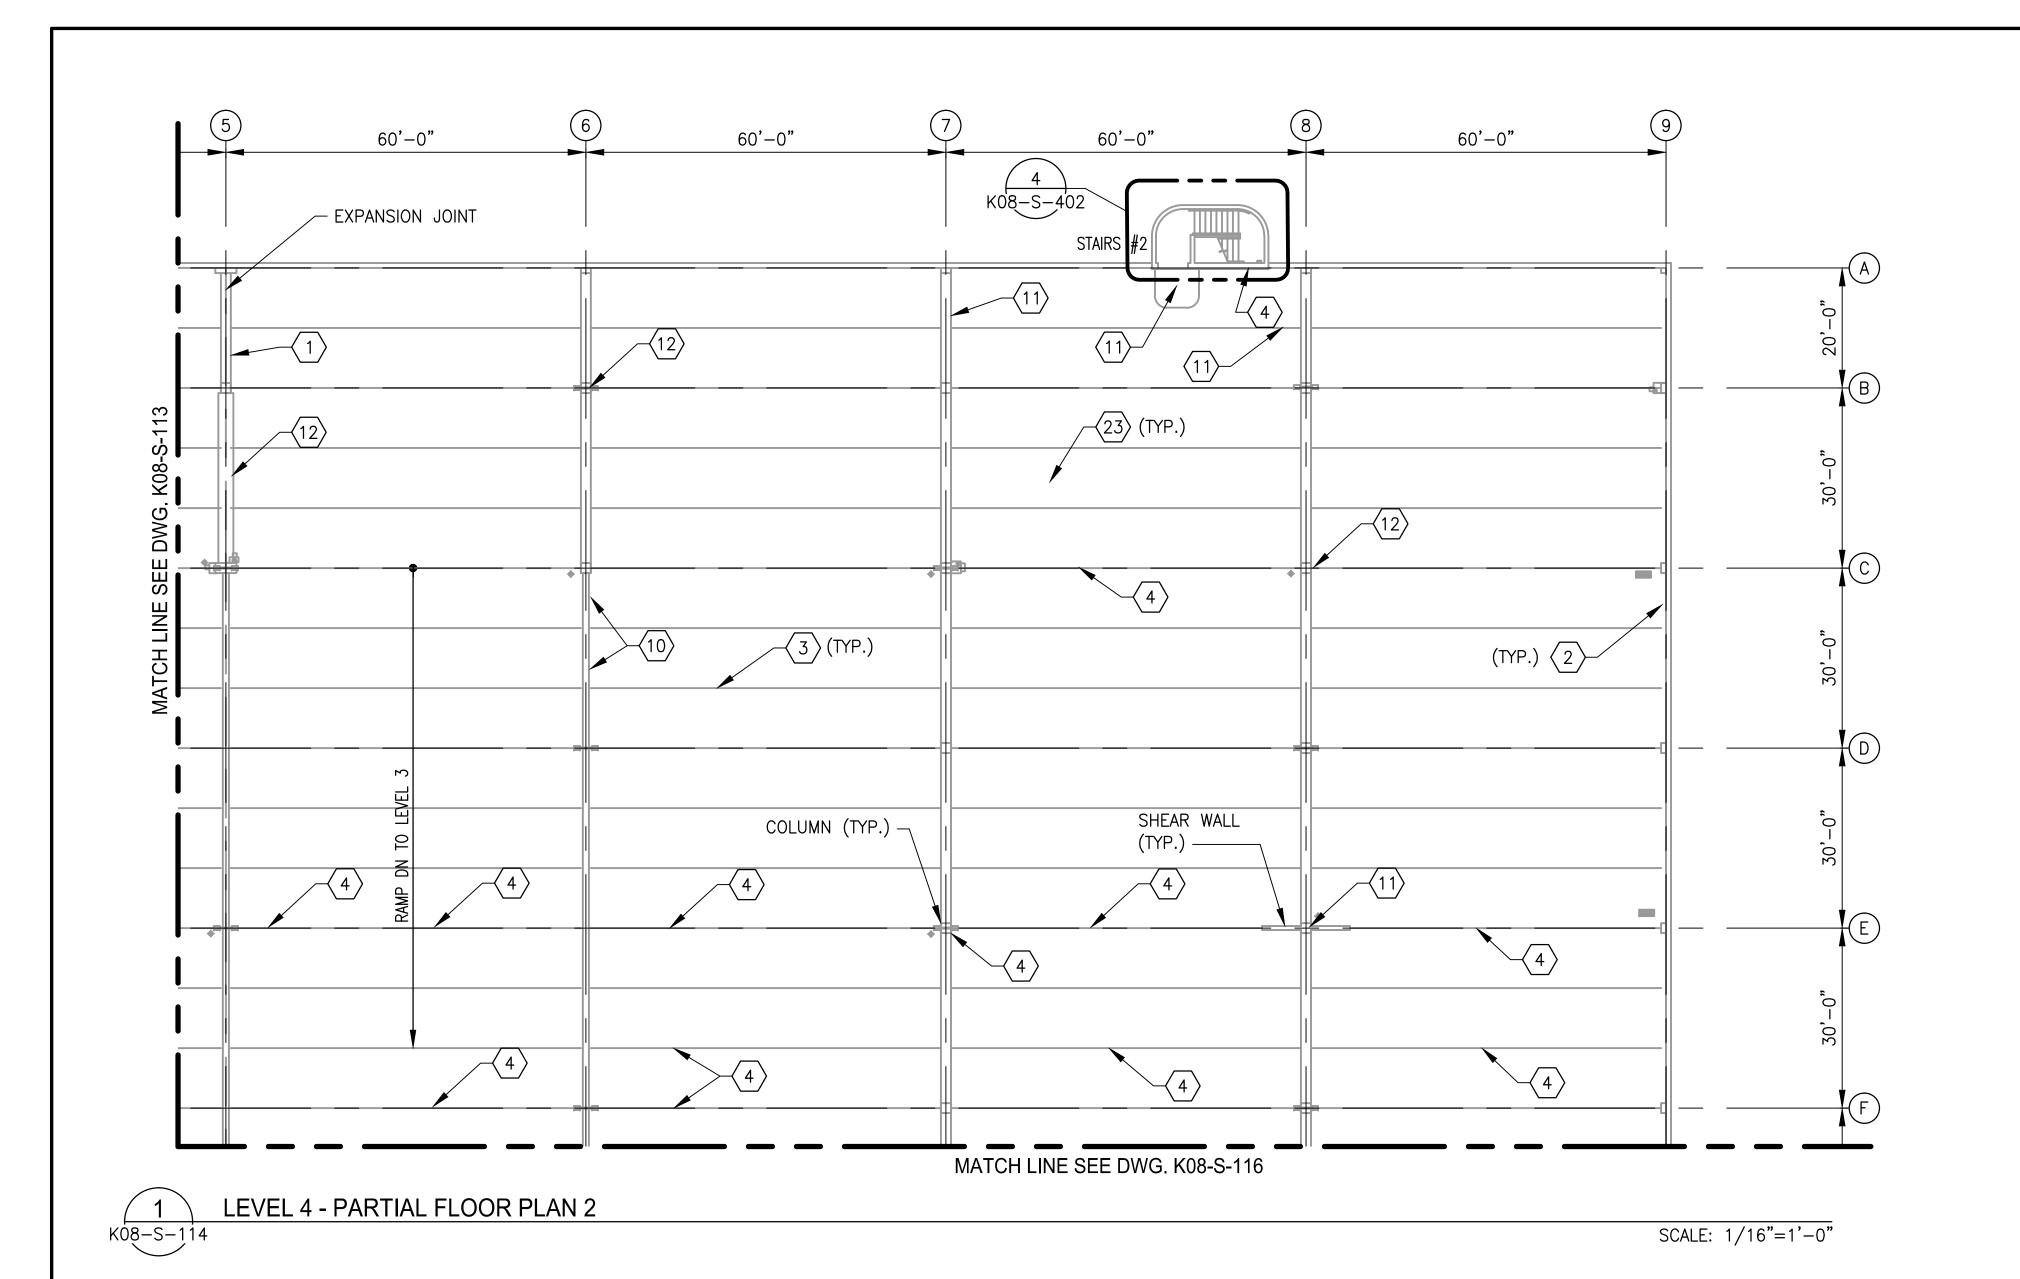

- 1. SEE DRAWING K08-S-002 FOR THE LIST OF KEY NOTES.
- 2. TRAFFIC BEARING MEMBRANE SHALL BE PROVIDED FOR ENTIRE PARKING AREA.
- 3. SEE DRAWING K08-S-113 FOR REPAIR QUANTITY TABLE ON THIS LEVEL.

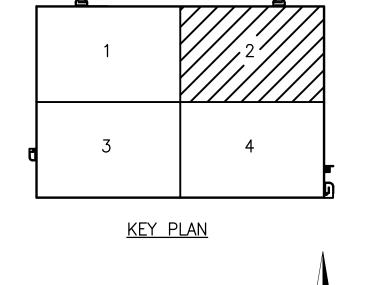

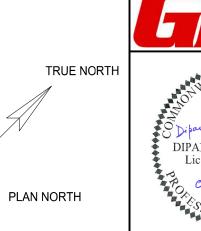

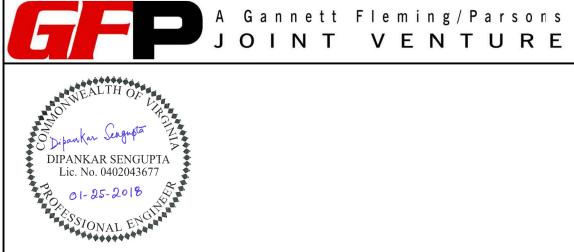


				REFERENCE DRAWINGS		REVISIONS				
DEGLOVED	K TSE	01/2018	NUMBER	TITLE	DATE	NUM	DESCRIPTION	IV meti		
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2.0		DATE								
CHECKED	D. SENGUPTA	01/2018								
		DATE						APPR		


WASHINGTON METROPOLITAN AREA TRANSIT AUTHORITY OFFICE OF THE CHIEF OPERATING OFFICER IRPG - FIXED FACILITIES Dipankar Sengusta 01/25/2018 DATE DIPANKAR SENGUPTA ENGINEER OF RECORD JOHN PURDY


ENGINEERING MANAGER


REHABILITATION OF PARKING GARAGES K08 - VIENNA STATION - NORTH PARKING GARAGE LEVEL 4 PARTIAL FLOOR PLAN 2

	. ,		
CONTRACT NO.	SCALE	DRAWING NO.	SHEET NO.
FQ18064	1/16"=1'-0"	K08-S-114	400 of 503

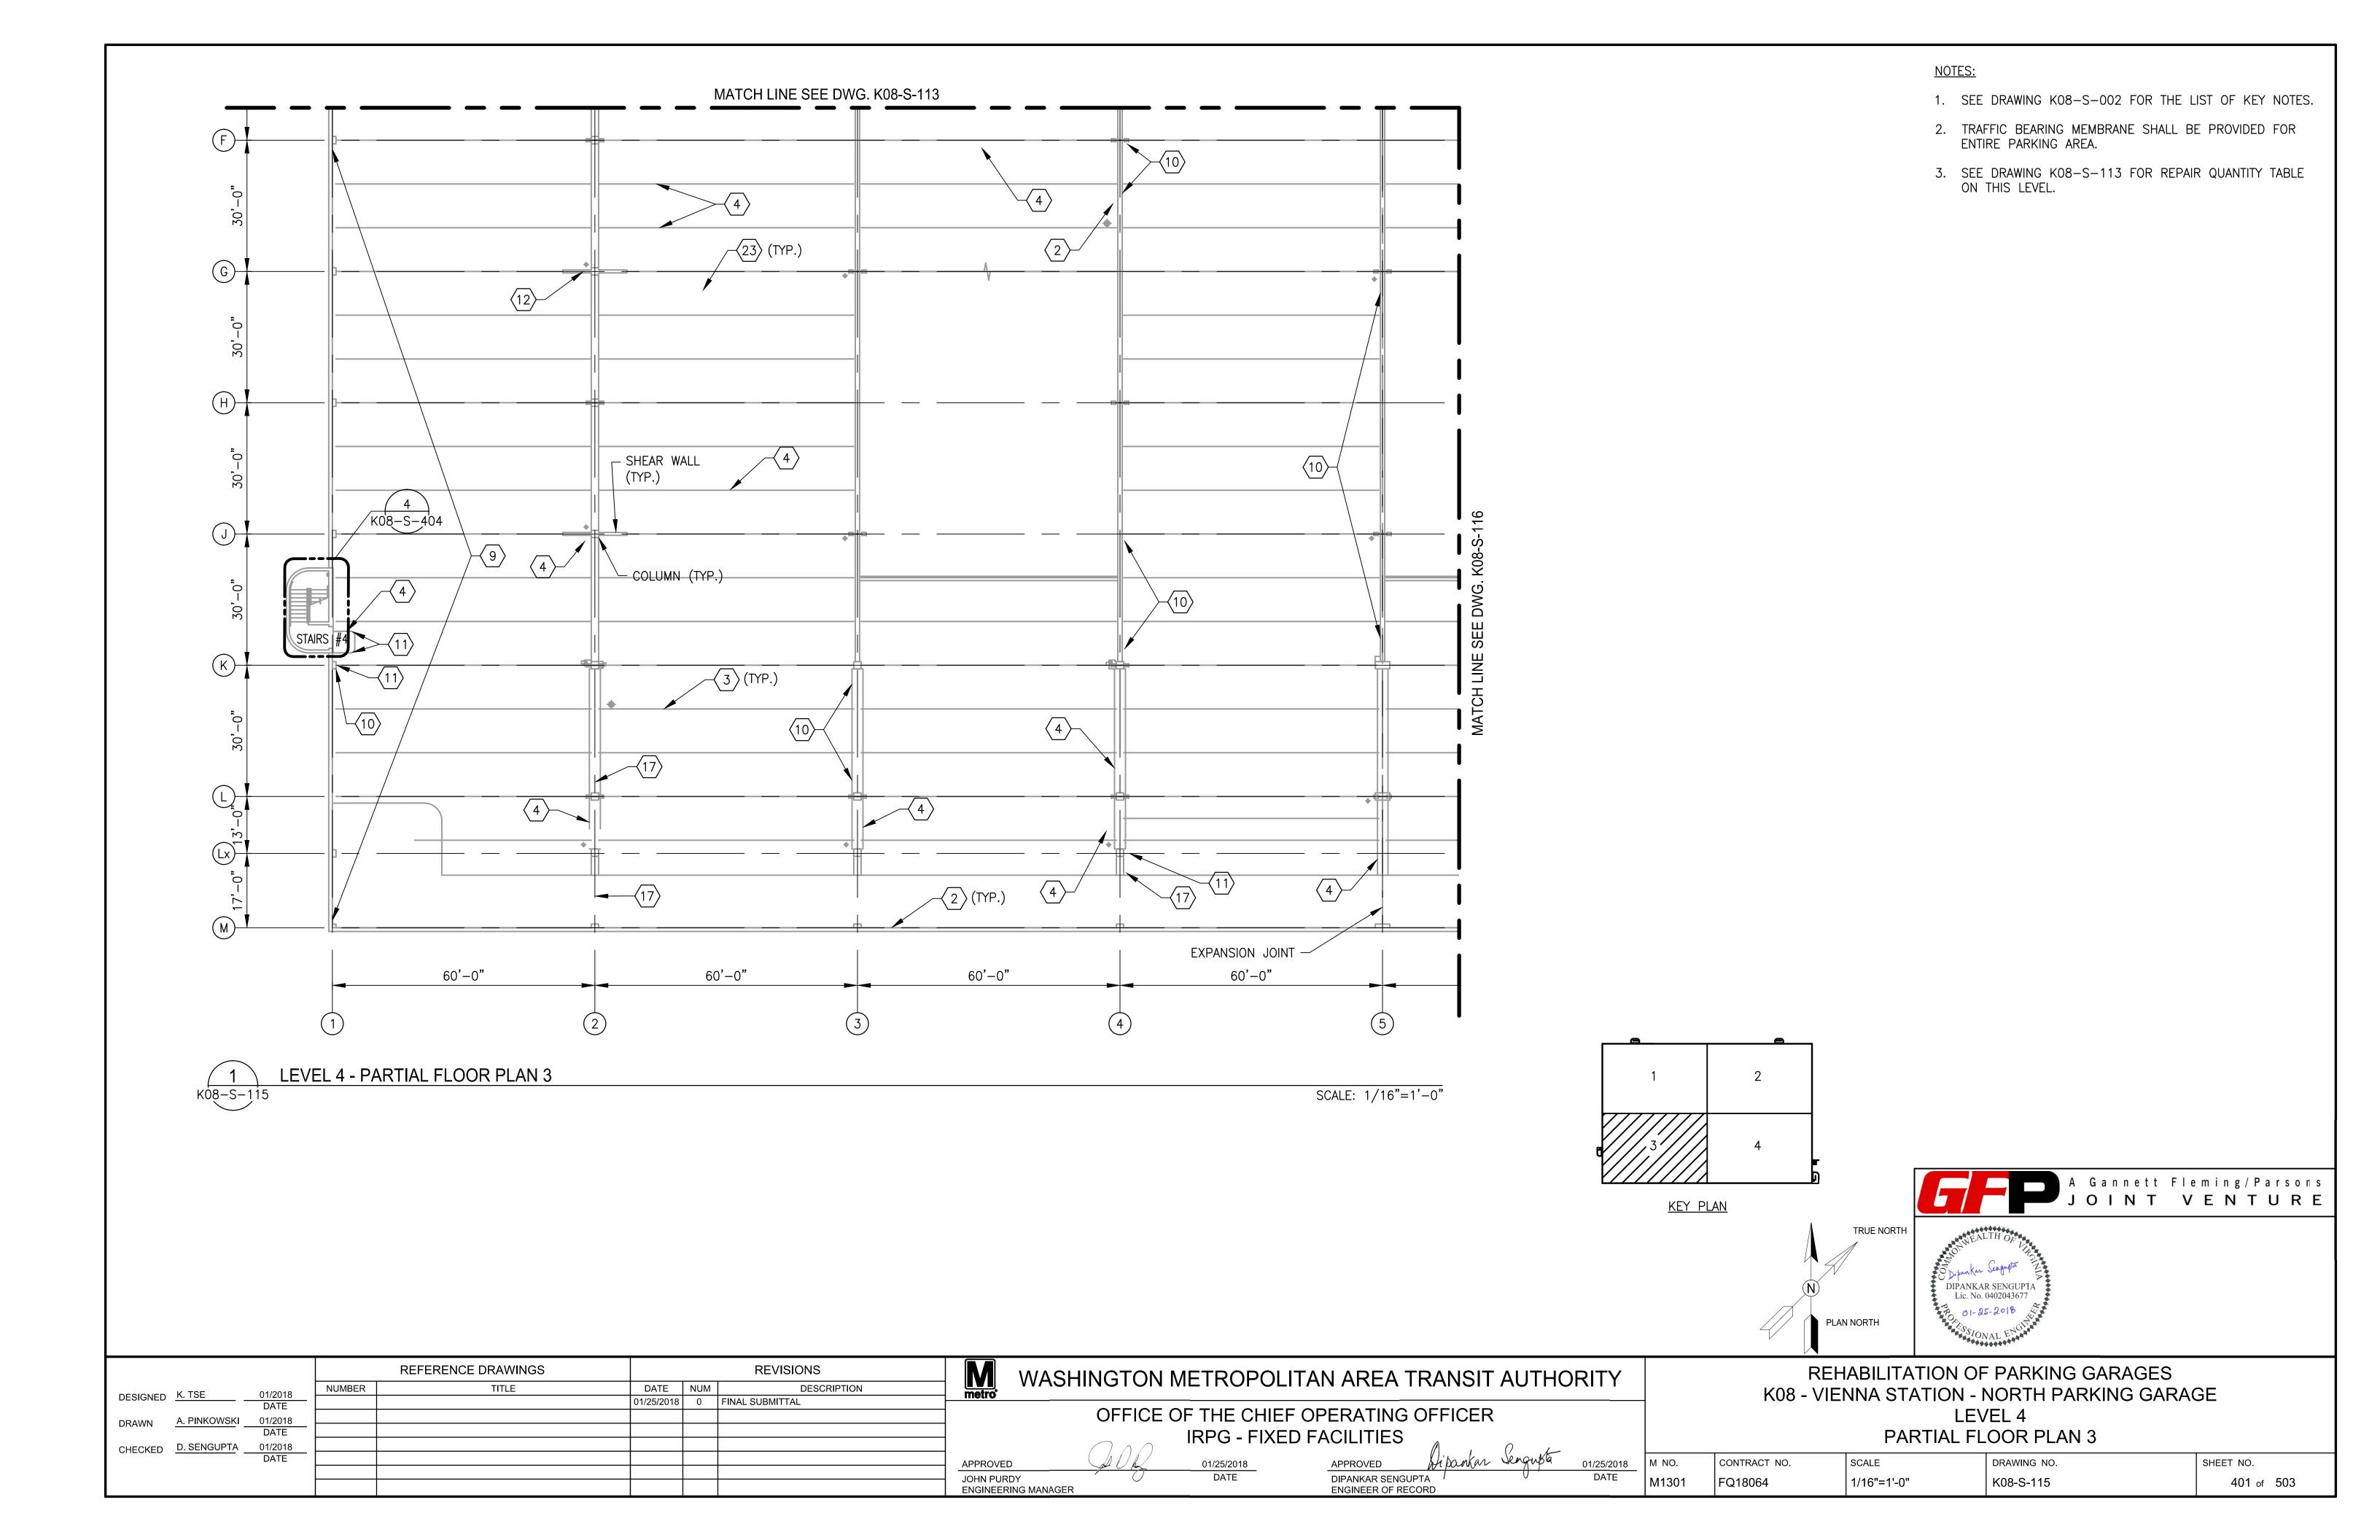


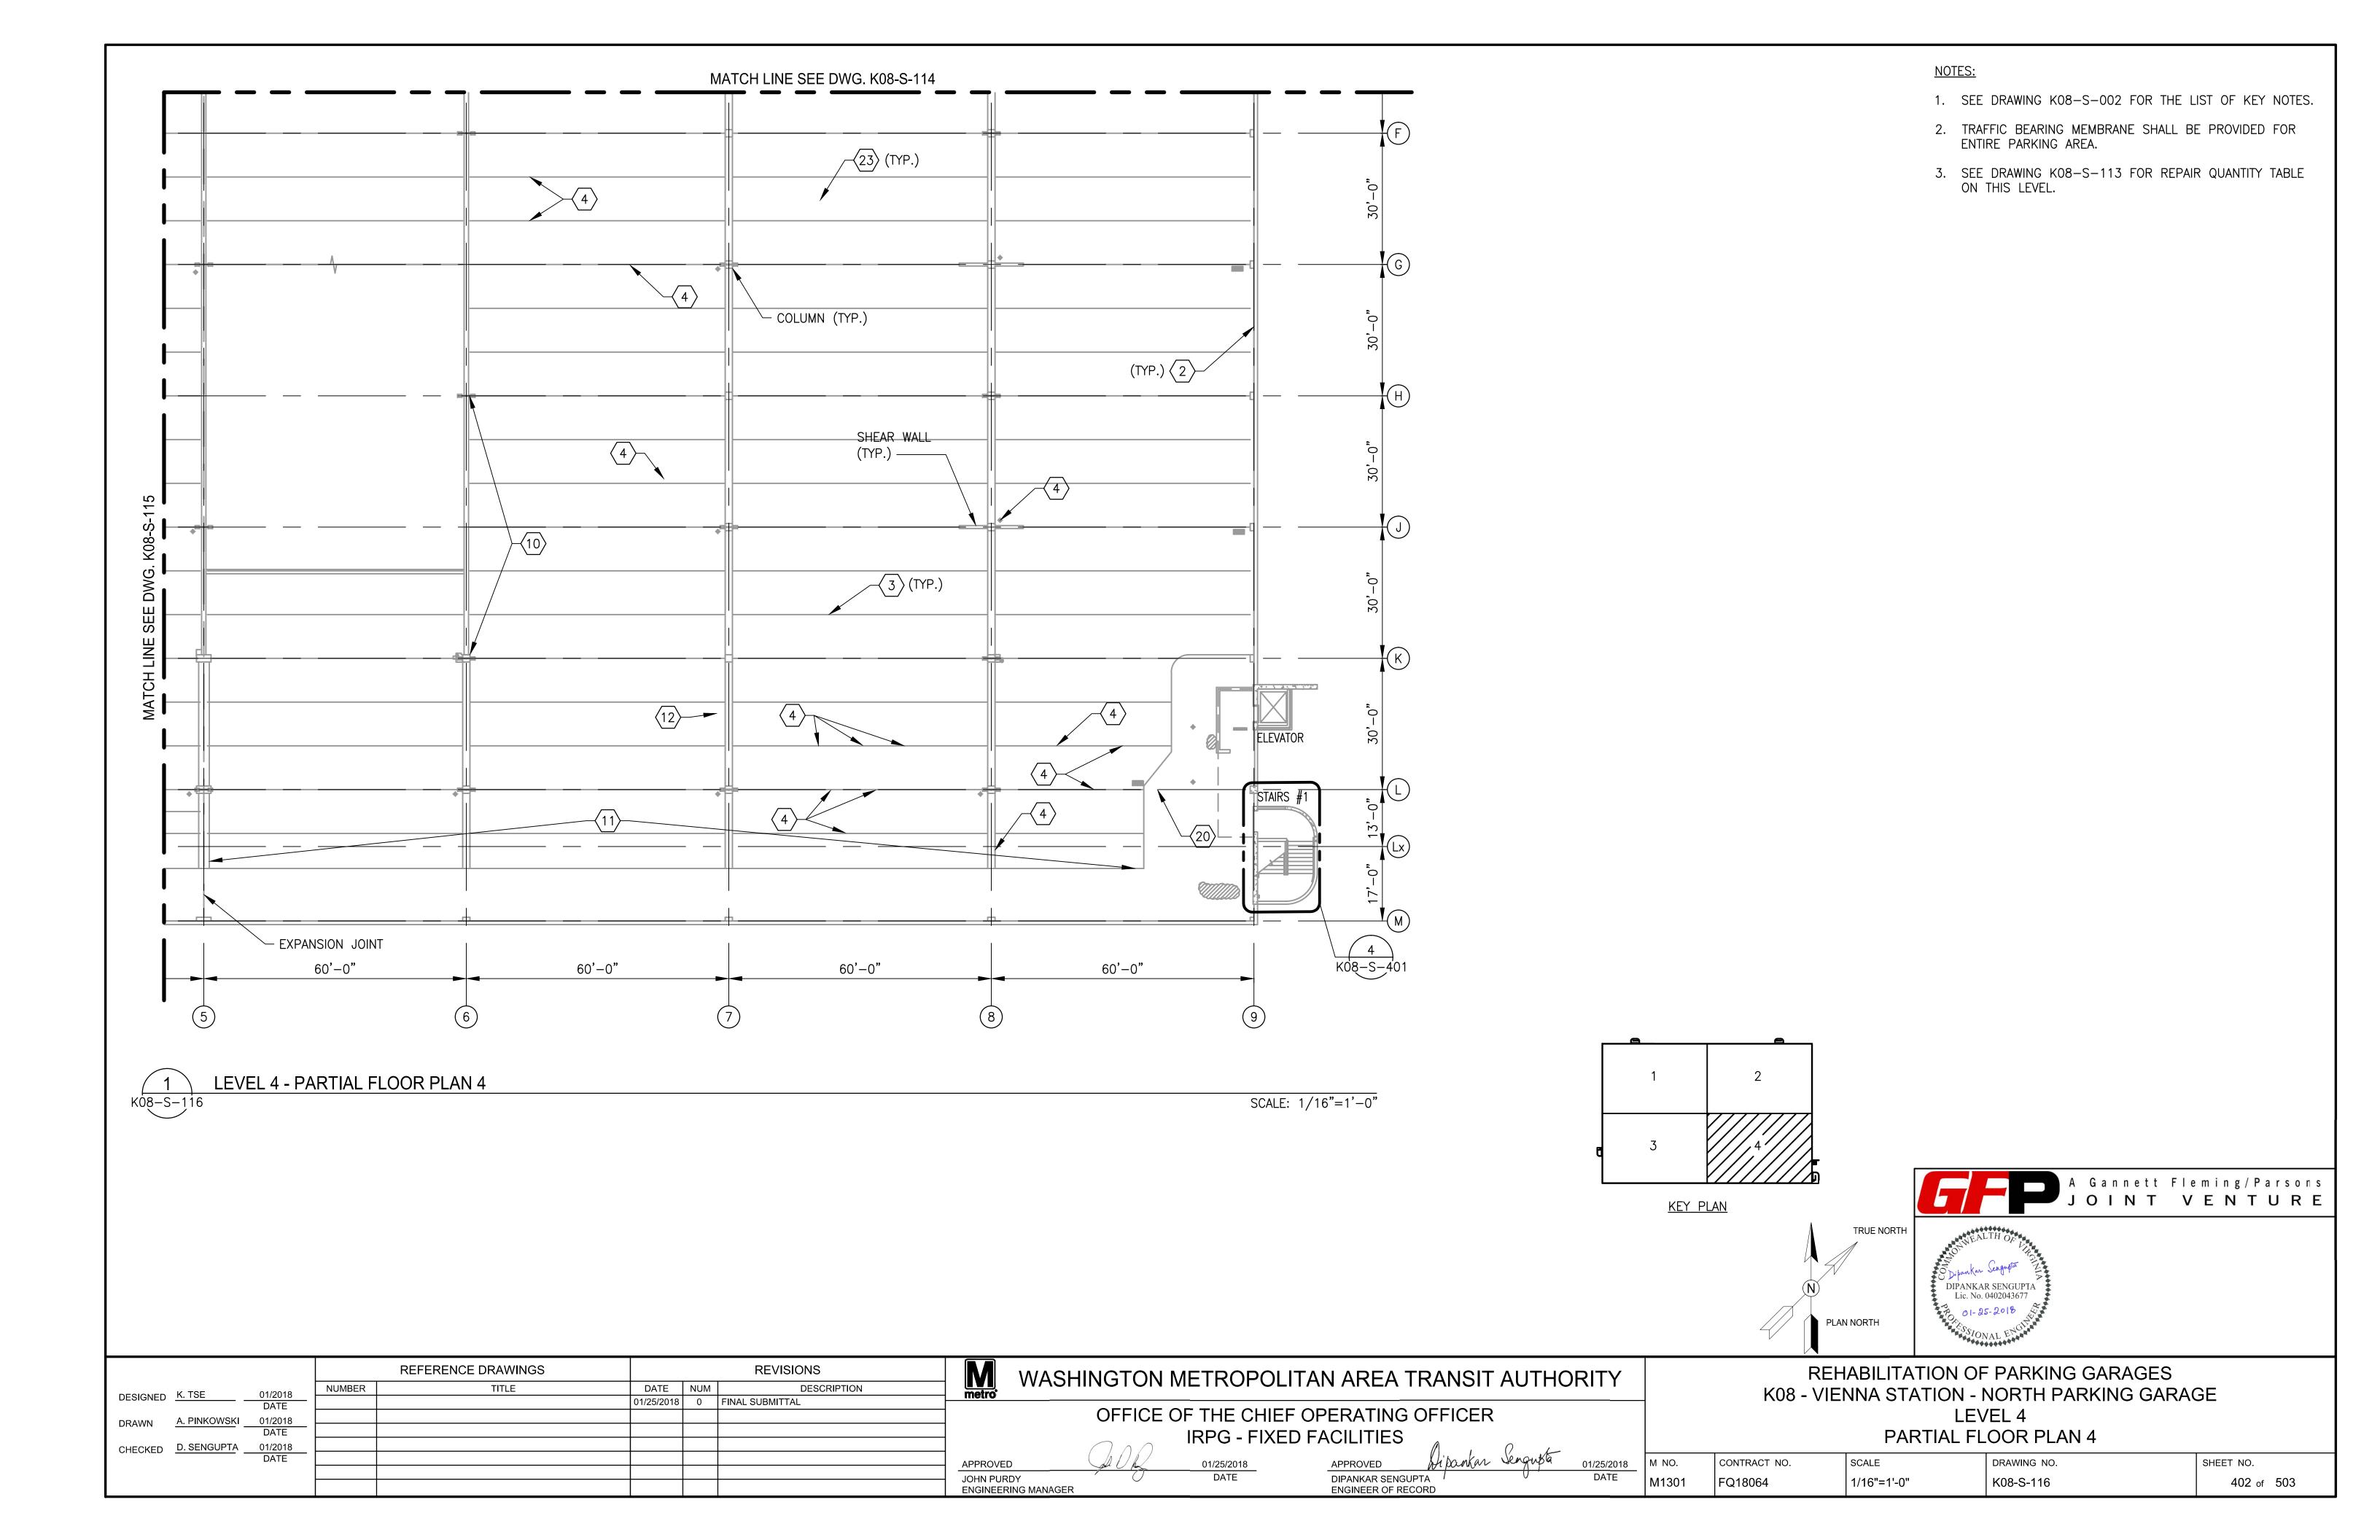

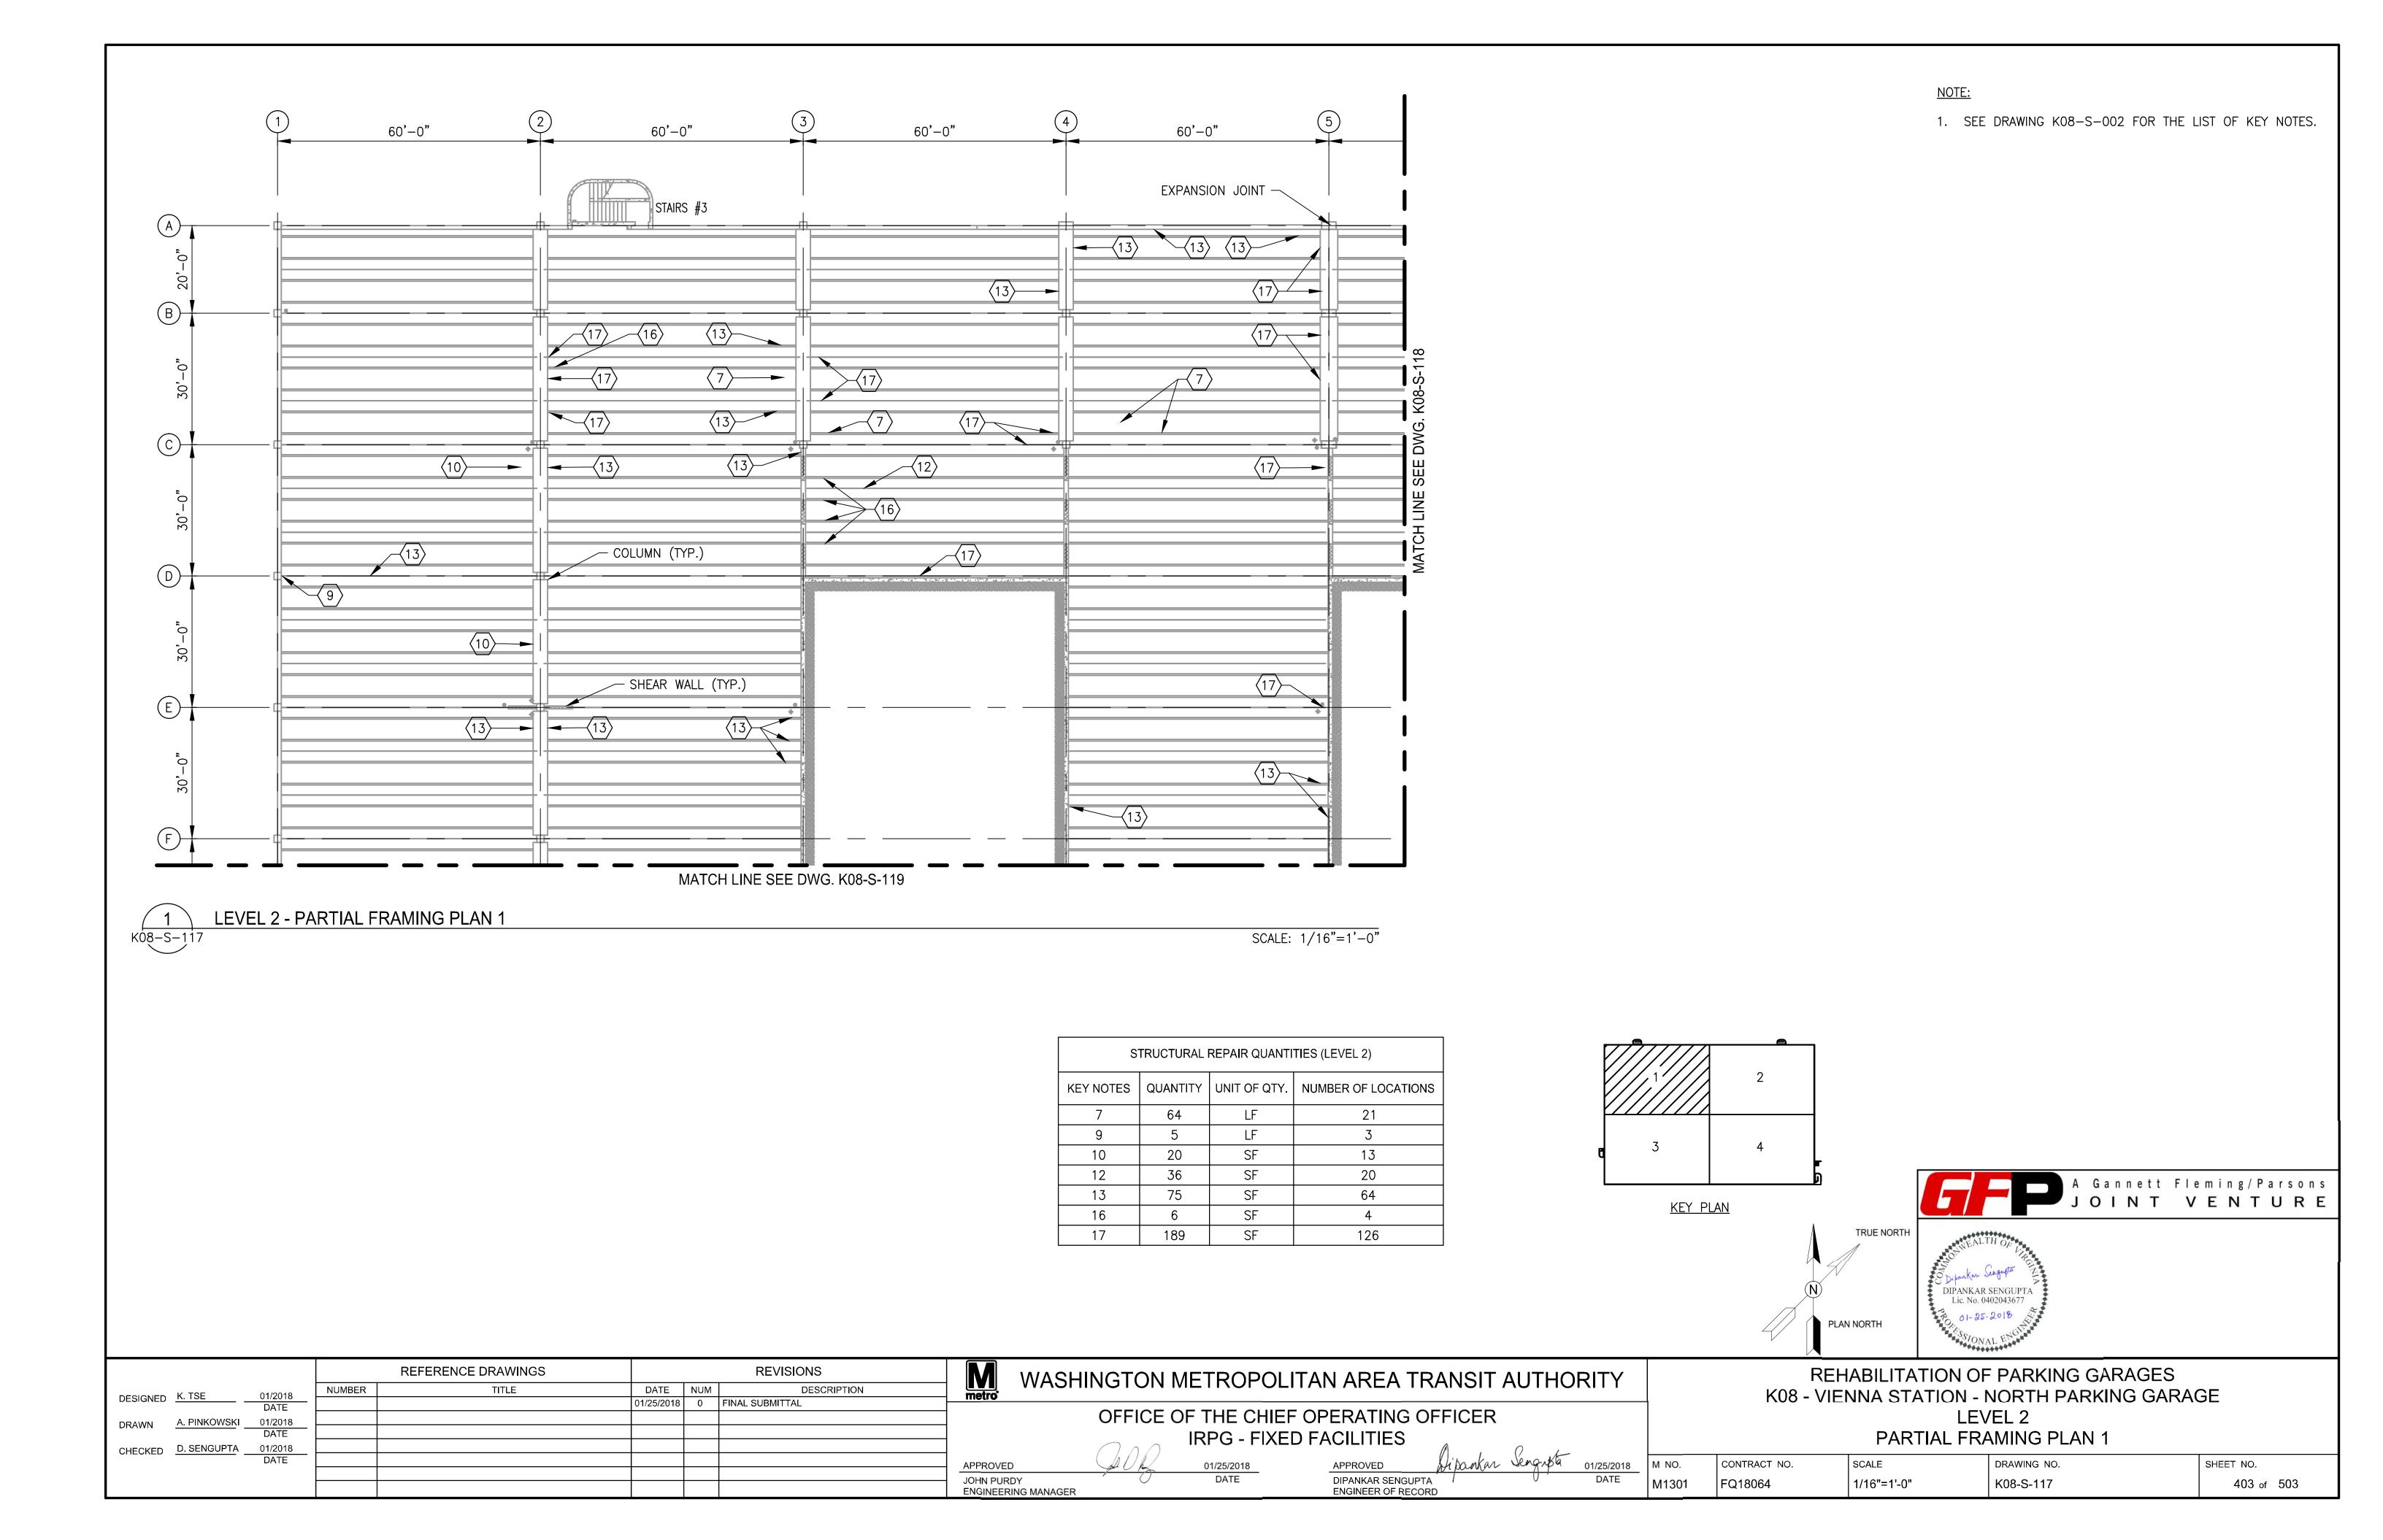


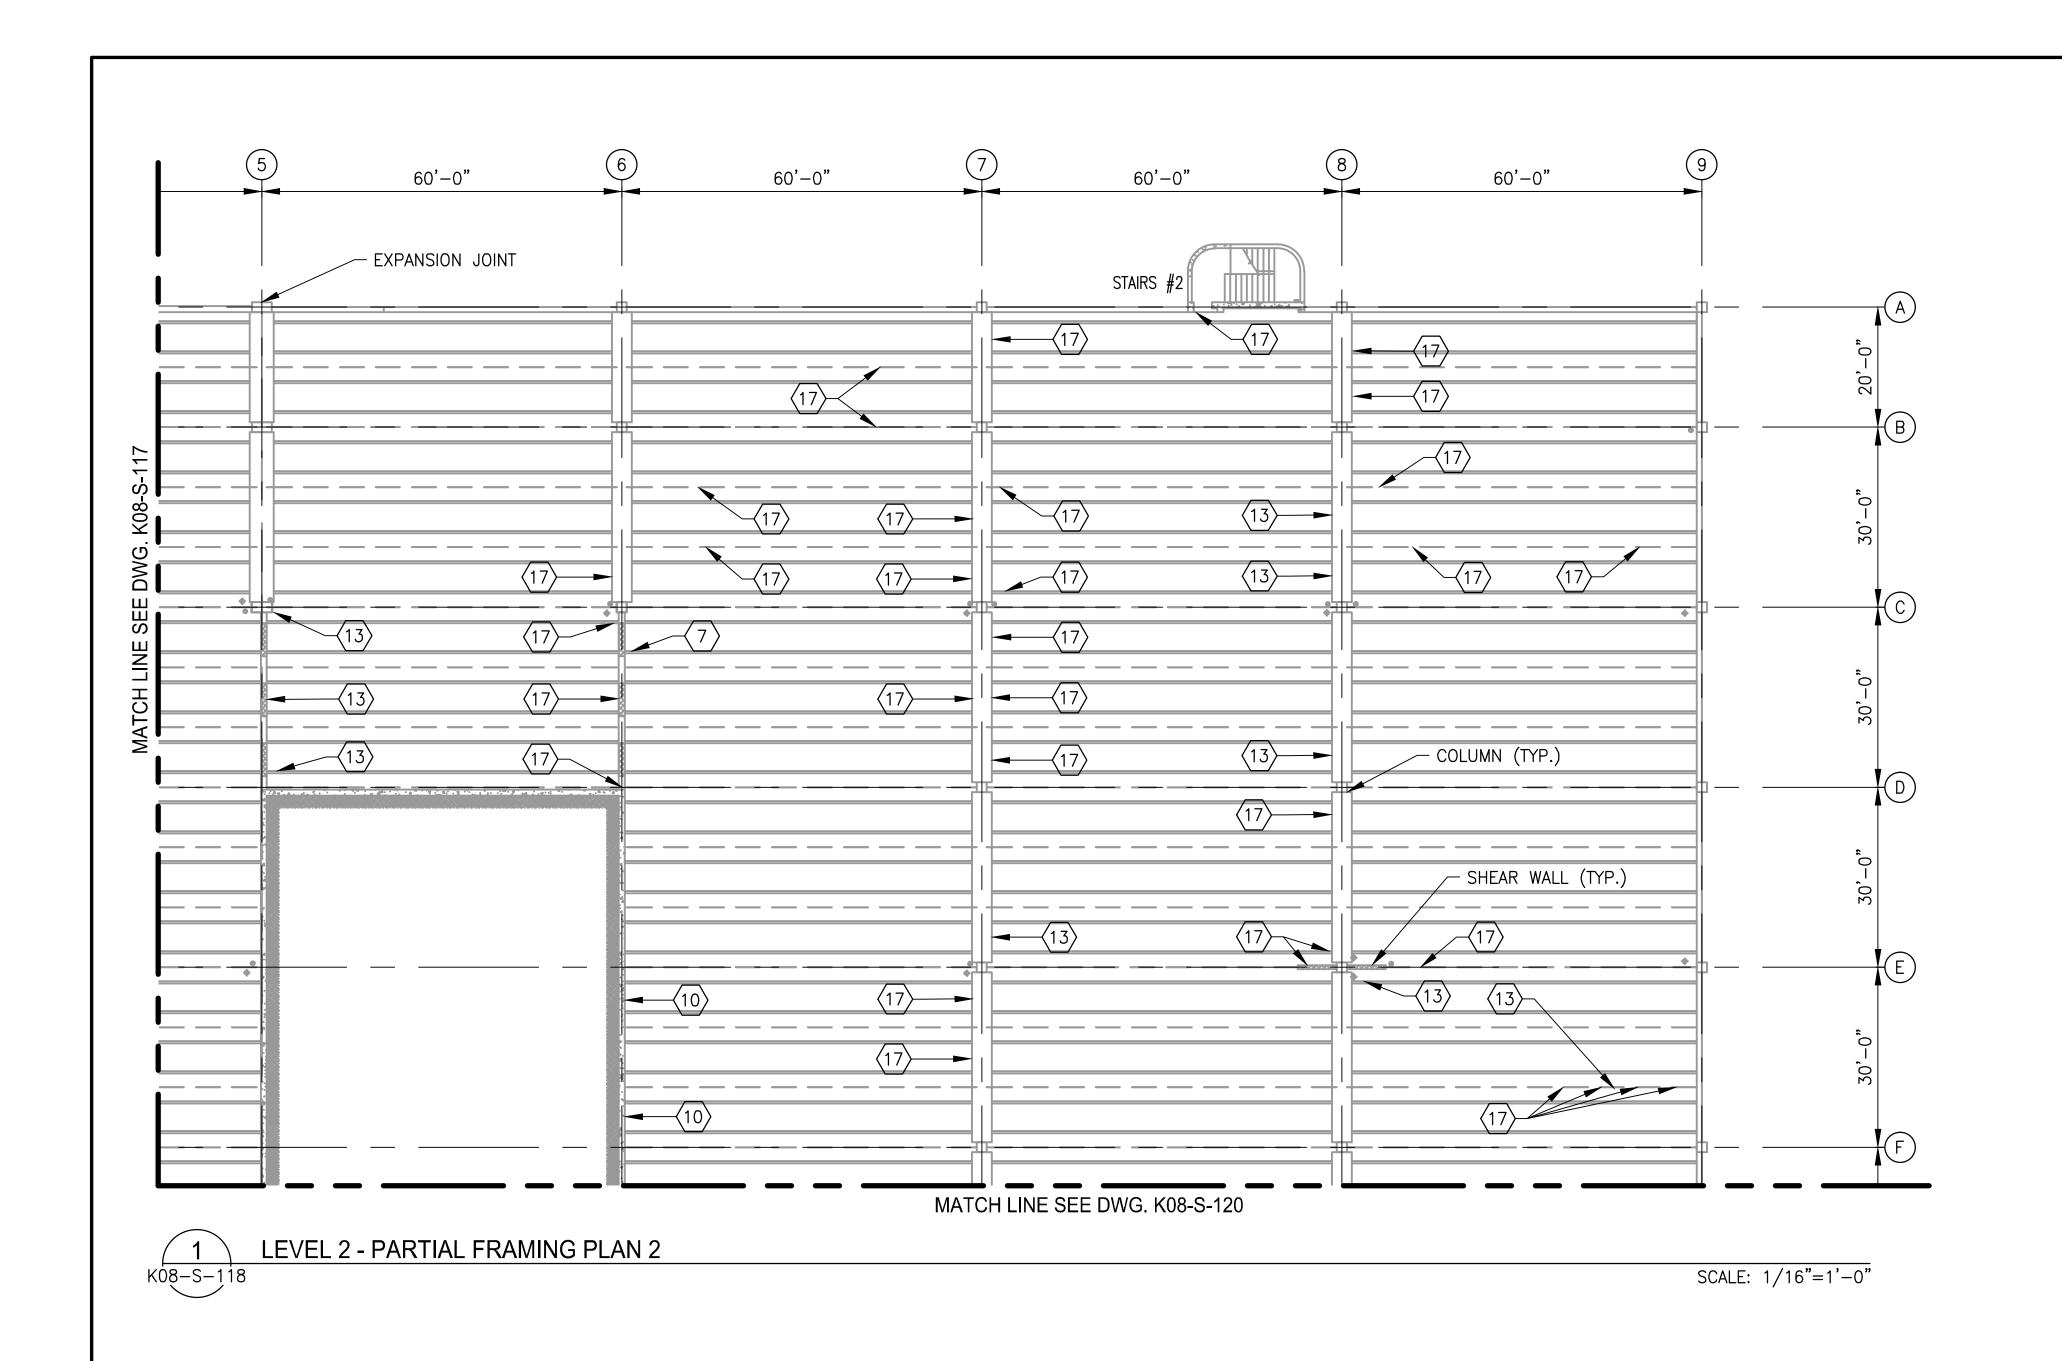



- 1. SEE DRAWING K08-S-002 FOR THE LIST OF KEY NOTES.
- 2. SEE DRAWING K08-S-117 FOR REPAIR QUANTITY TABLE ON THIS LEVEL.

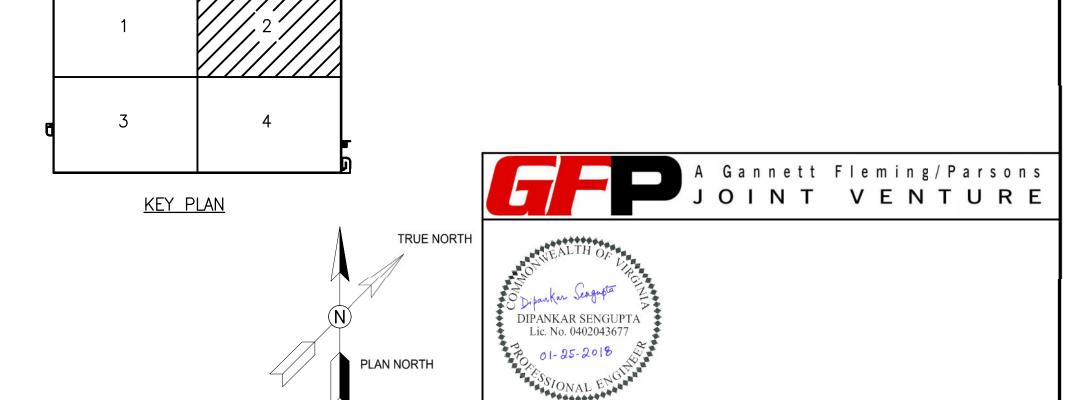


		RENCE DRAWINGS		REVISIONS	M WASHI	WASHINGTON METROPOLITAN AREA TRANSIT AUTHORITY		REHABILITATION OF PARKING GARAGES							
DESIGNED <u>K. TSE</u> 01/2018	NUMBER	IIILE	DATE NUM	DESCRIPTION	— metro							K08 - V	IFNNA STATION - I	NORTH PARKING GARA	GE l
DATE			01/25/2018 0	FINAL SUBMITTAL	_		THE CHIE		EELCED						
DRAWN A. PINKOWSKI 01/2018					<u> </u>	OFFICE OF	LUECUIE	F OPERATING O	FFICER				LEV	/EL 2	
DATE					_		RPG - FIXE	ED FACILITIES					PARTIAI FRA	AMING PLAN 2	
CHECKED D. SENGUPTA 01/2018					_	$\bigcap \bigcap \bigcap$			A , O +				. , ((()) () () ()		
DATE					APPROVED	AUR	01/25/2018	APPROVED	Shibankar Jengusta	01/25/2018	M NO.	CONTRACT NO.	SCALE	DRAWING NO.	SHEET NO.
					JOHN PURDY	7 0	DATE	DIPANKAR SENGUPTA	A A	DATE	M4201	FQ18064	1/16"=1'-0"	K08-S-118	404 of 503
					ENGINEERING MANAGER			ENGINEER OF RECOR			M1301	FQ10004	1/16 - 1 -0	NU0-3-110	404 of 503

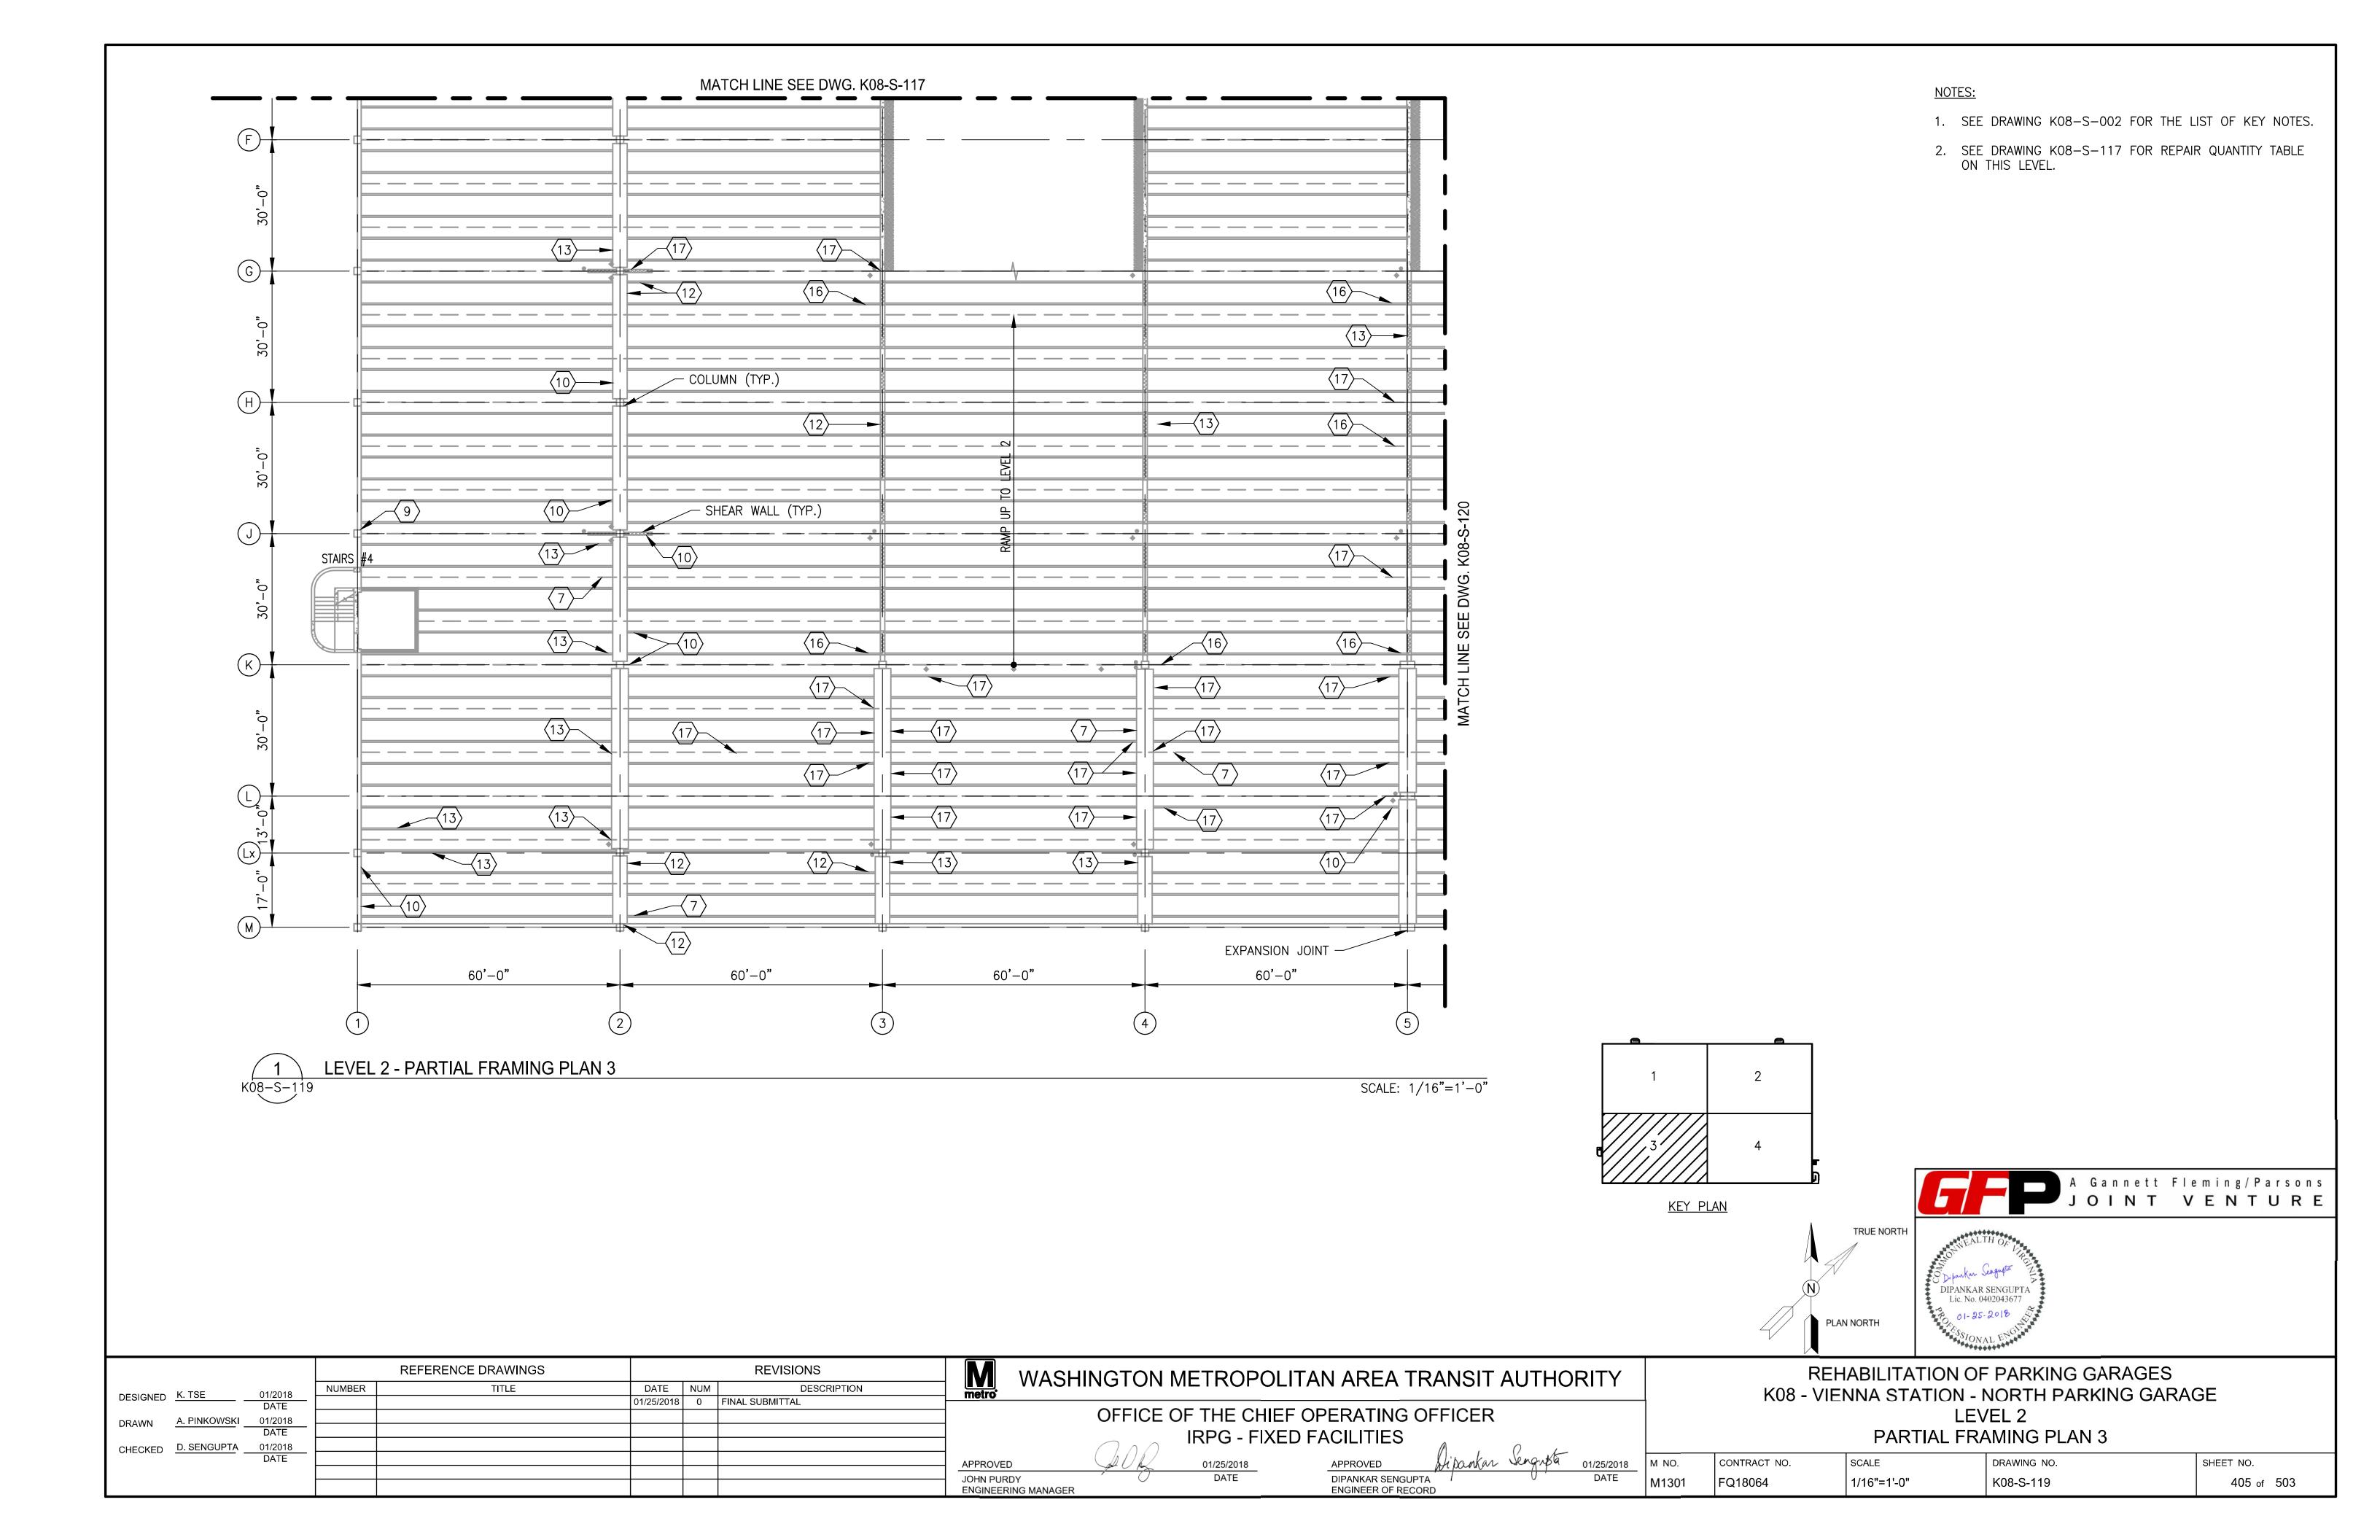

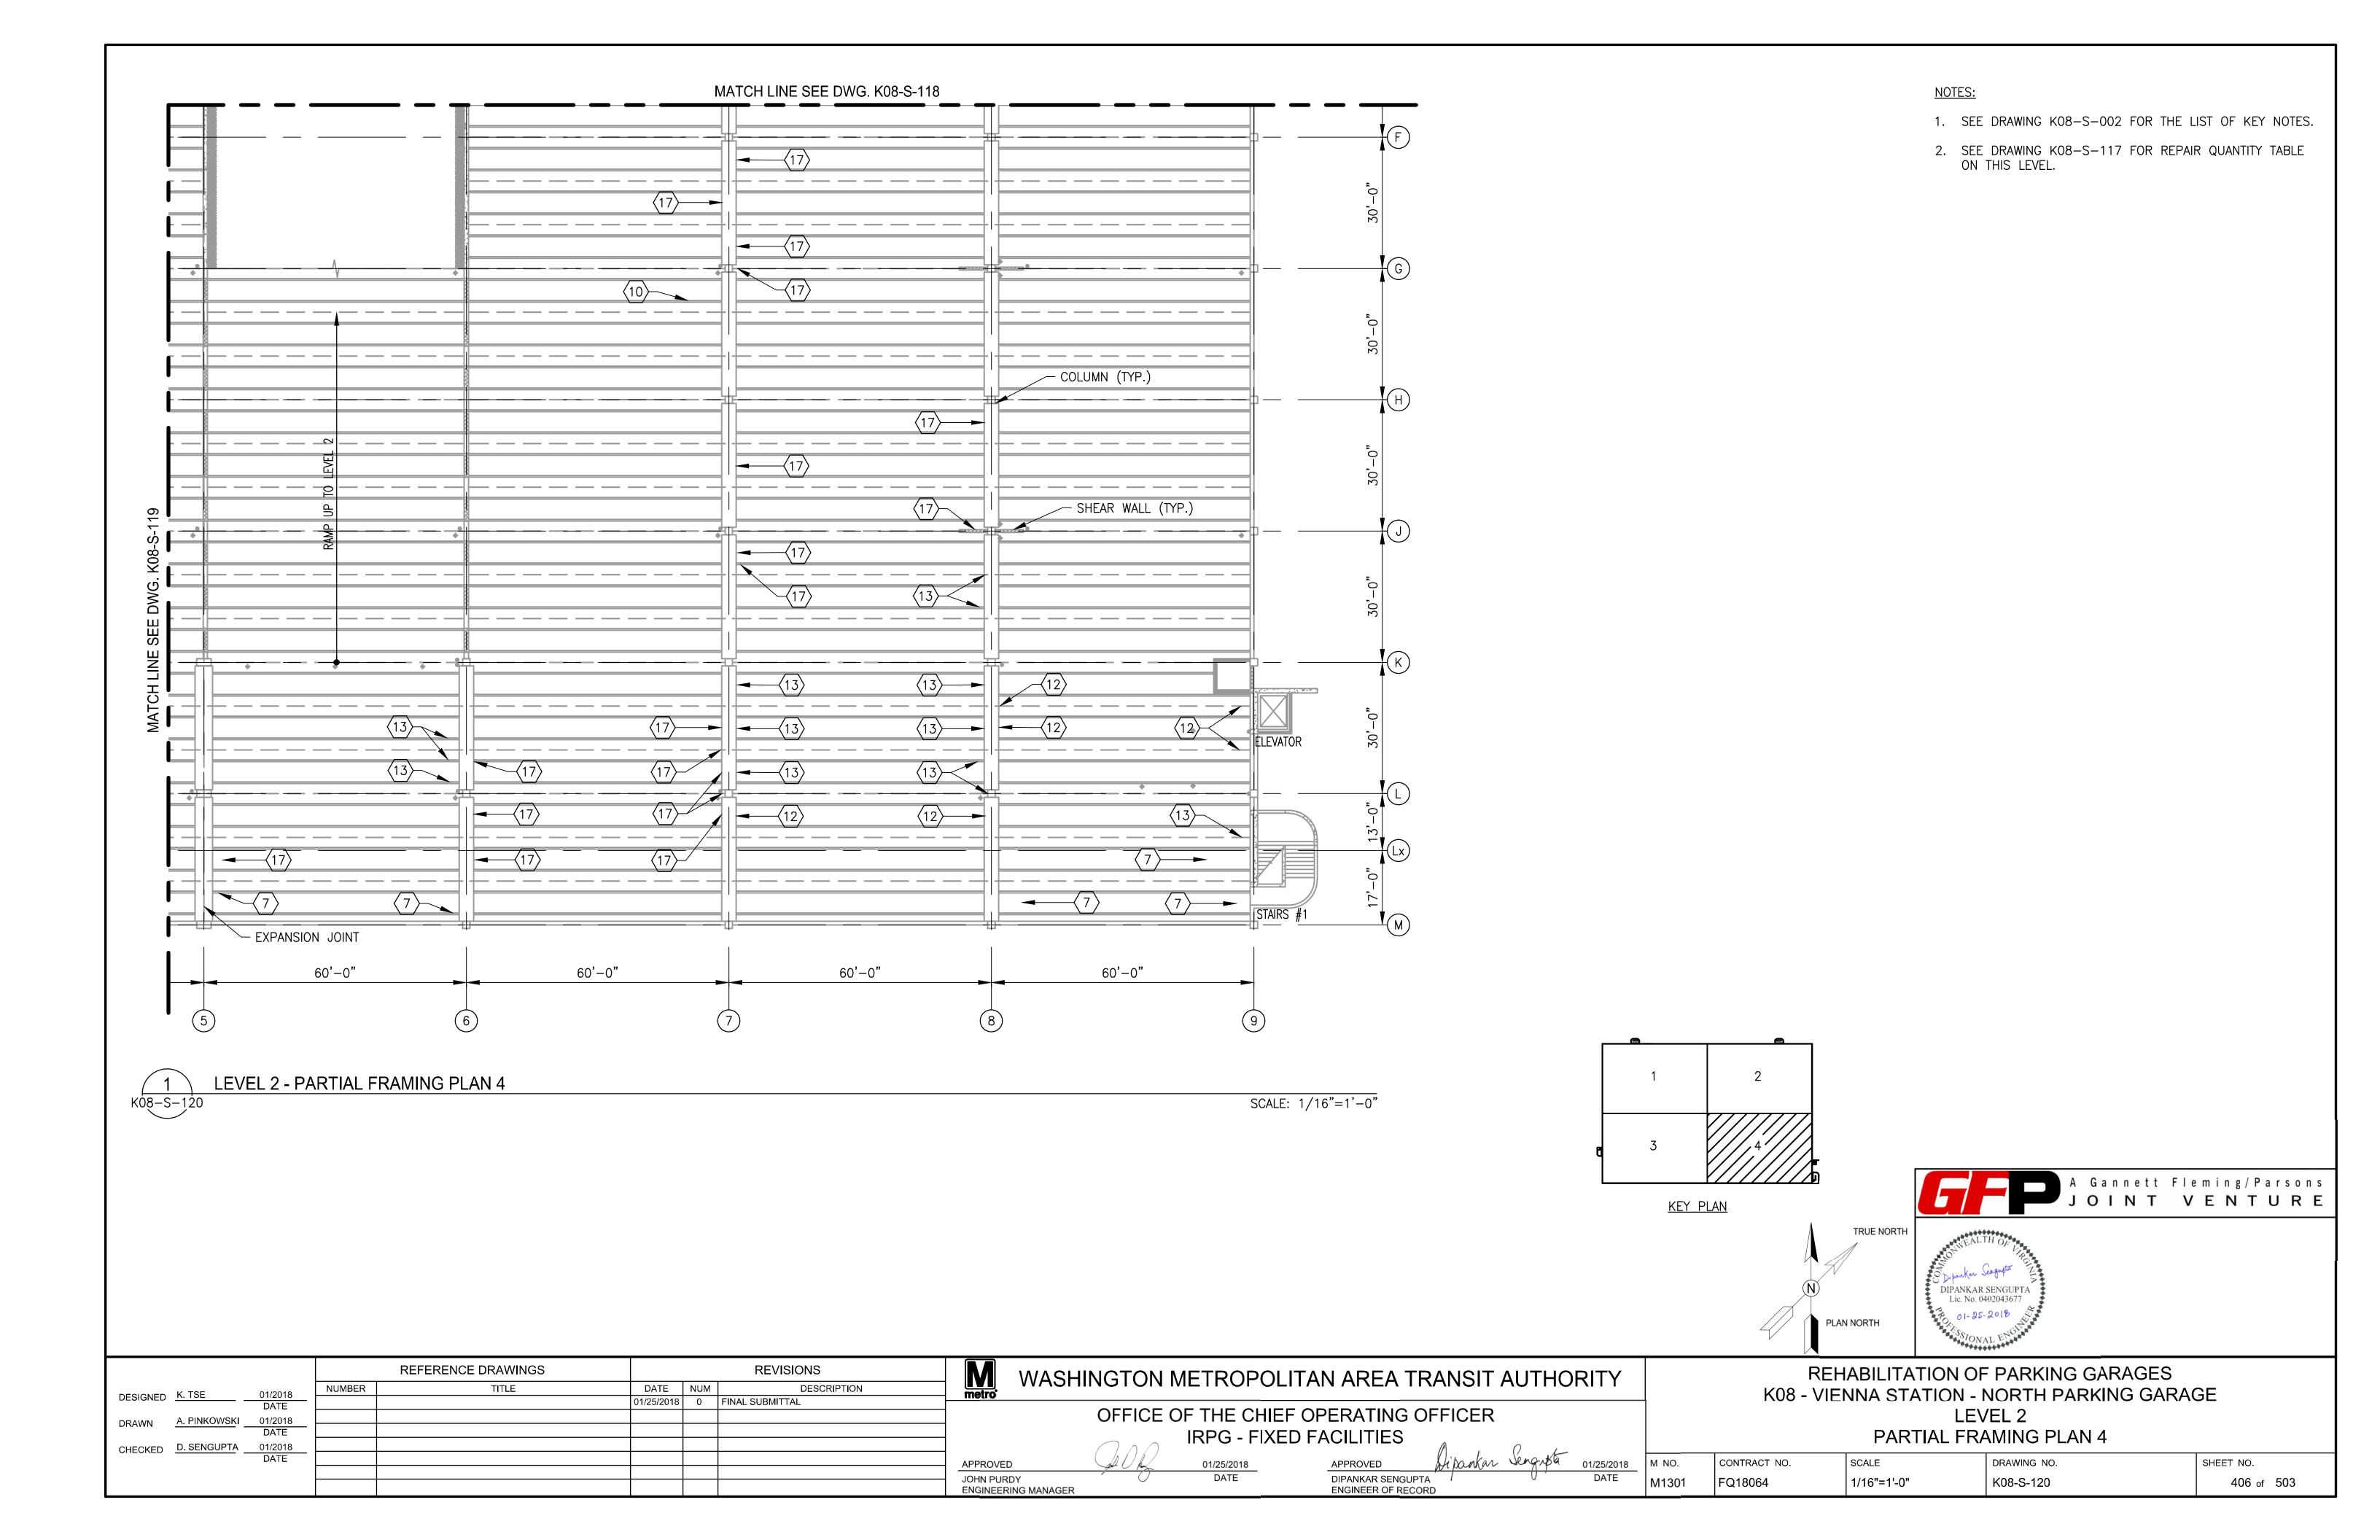

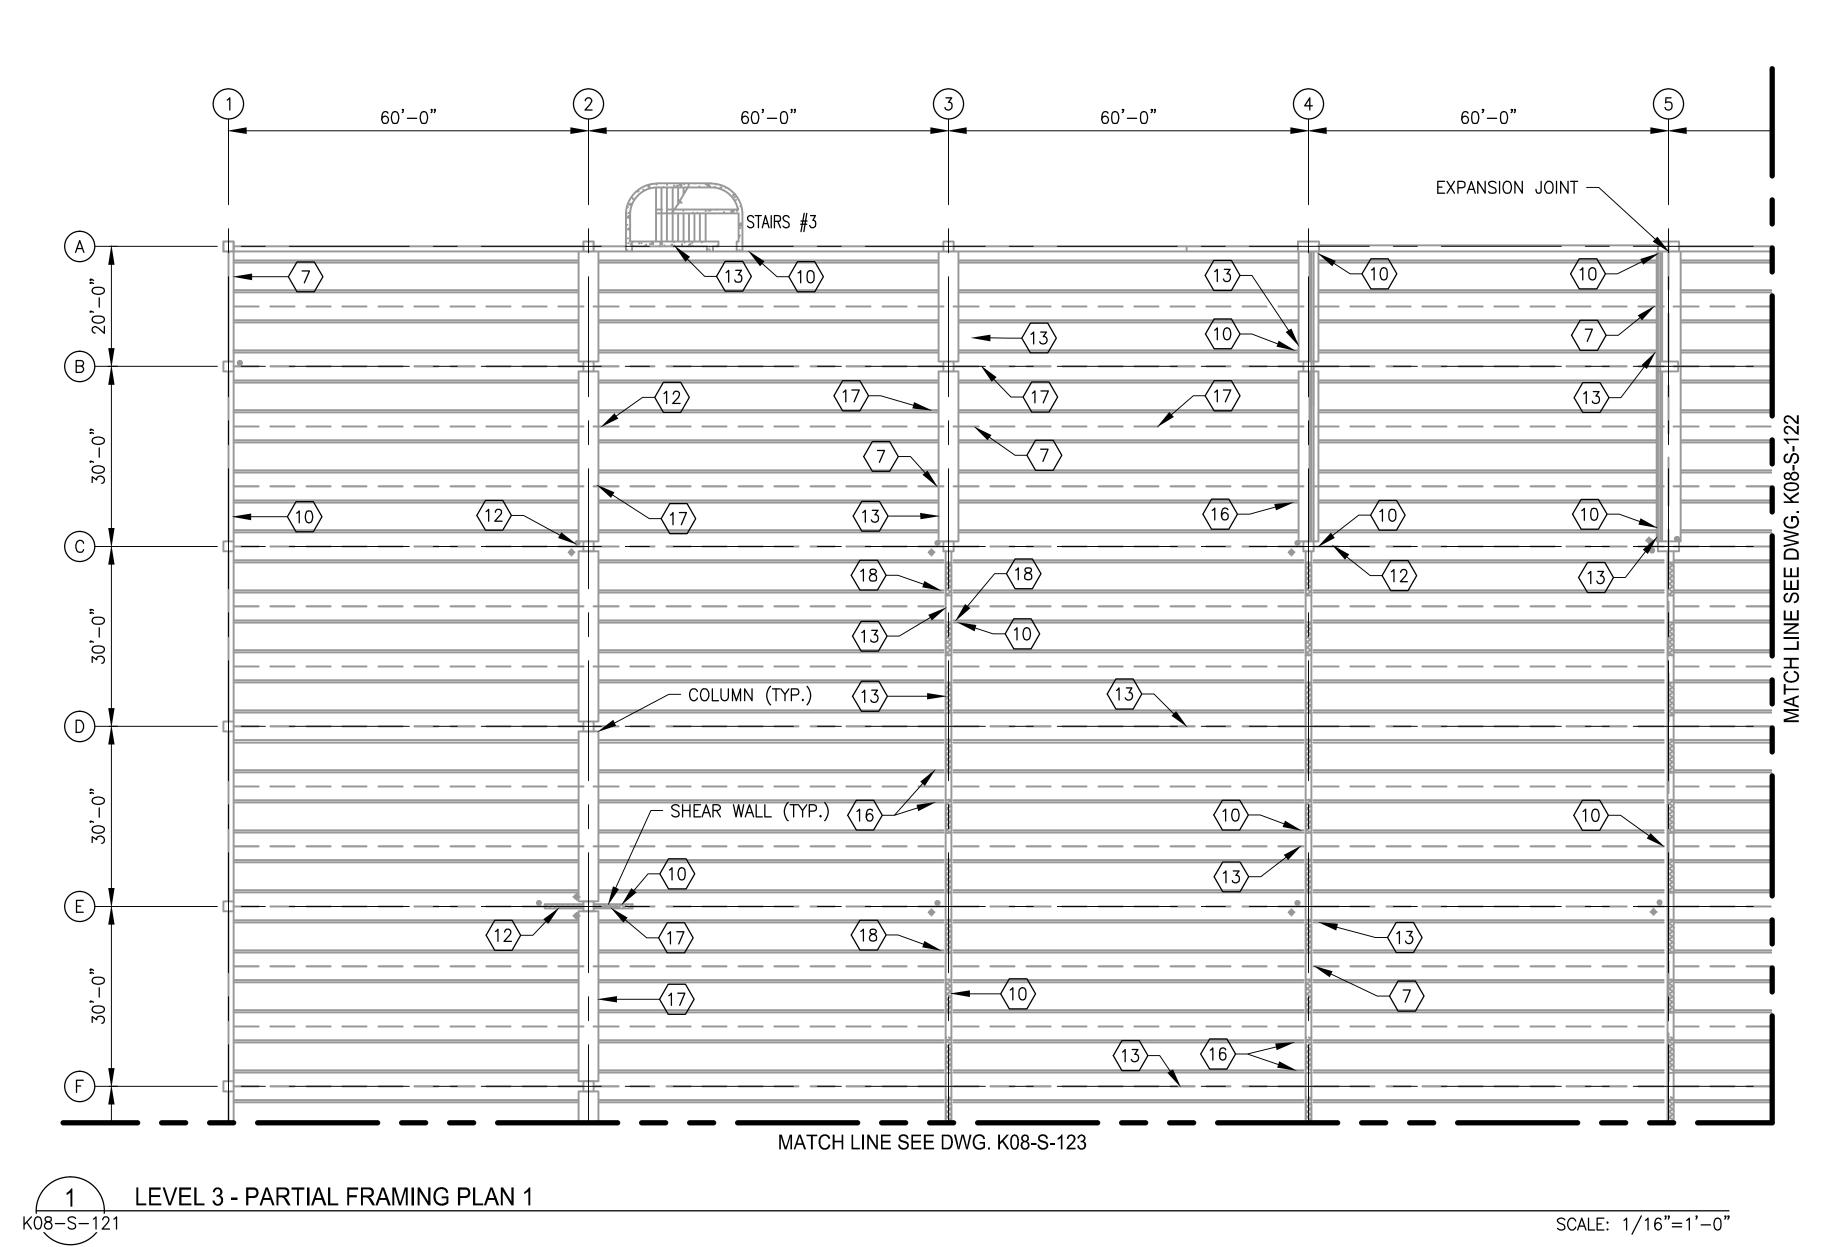

STRUCTURAL REPAIR QUANTITIES (LEVEL 2) KEY NOTES | QUANTITY | UNIT OF QTY. | NUMBER OF LOCATIONS LF 11 LF 216 SF 58 21 SF 11 12 59 SF 14 13 161 SF 35 SF 23 16 65 17 267 SF 48 18 EΑ 37 63 SF

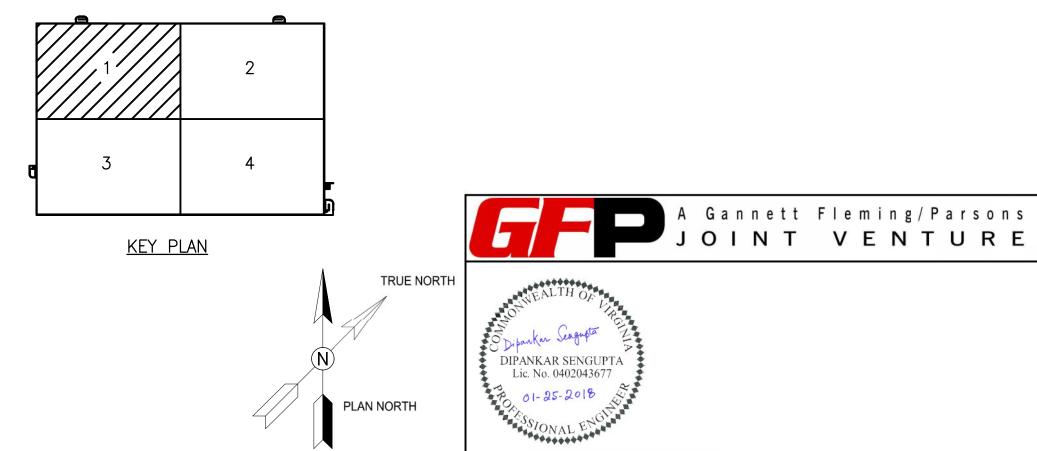

NOTE:

1. SEE DRAWING K08-S-002 FOR THE LIST OF KEY NOTES.

				REFERENCE DRAWINGS			REVISIONS	M WASH	INCTO
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DRAWN	A. PINKOWSKI	01/2018							OFFI
		DATE							
CHECKED	D. SENGUPTA	01/2018 DATE							
		DATE						APPROVED	JA U
								JOHN PURDY ENGINEERING MANAGER	(

TON METROPOLITAN AREA TRANSIT AUTHORITY FICE OF THE CHIEF OPERATING OFFICER IRPG - FIXED FACILITIES


DIPANKAR SENGUPTA ENGINEER OF RECORD

01/25/2018


REHABILITATION OF PARKING GARAGES K08 - VIENNA STATION - NORTH PARKING GARAGE LEVEL 3 PARTIAL FRAMING PLAN 1

CONTRACT NO.	SCALE	DRAWING NO.	SHEET NO.					
FQ18064	1/16"=1'-0"	K08-S-121	407 of					

407 of 503

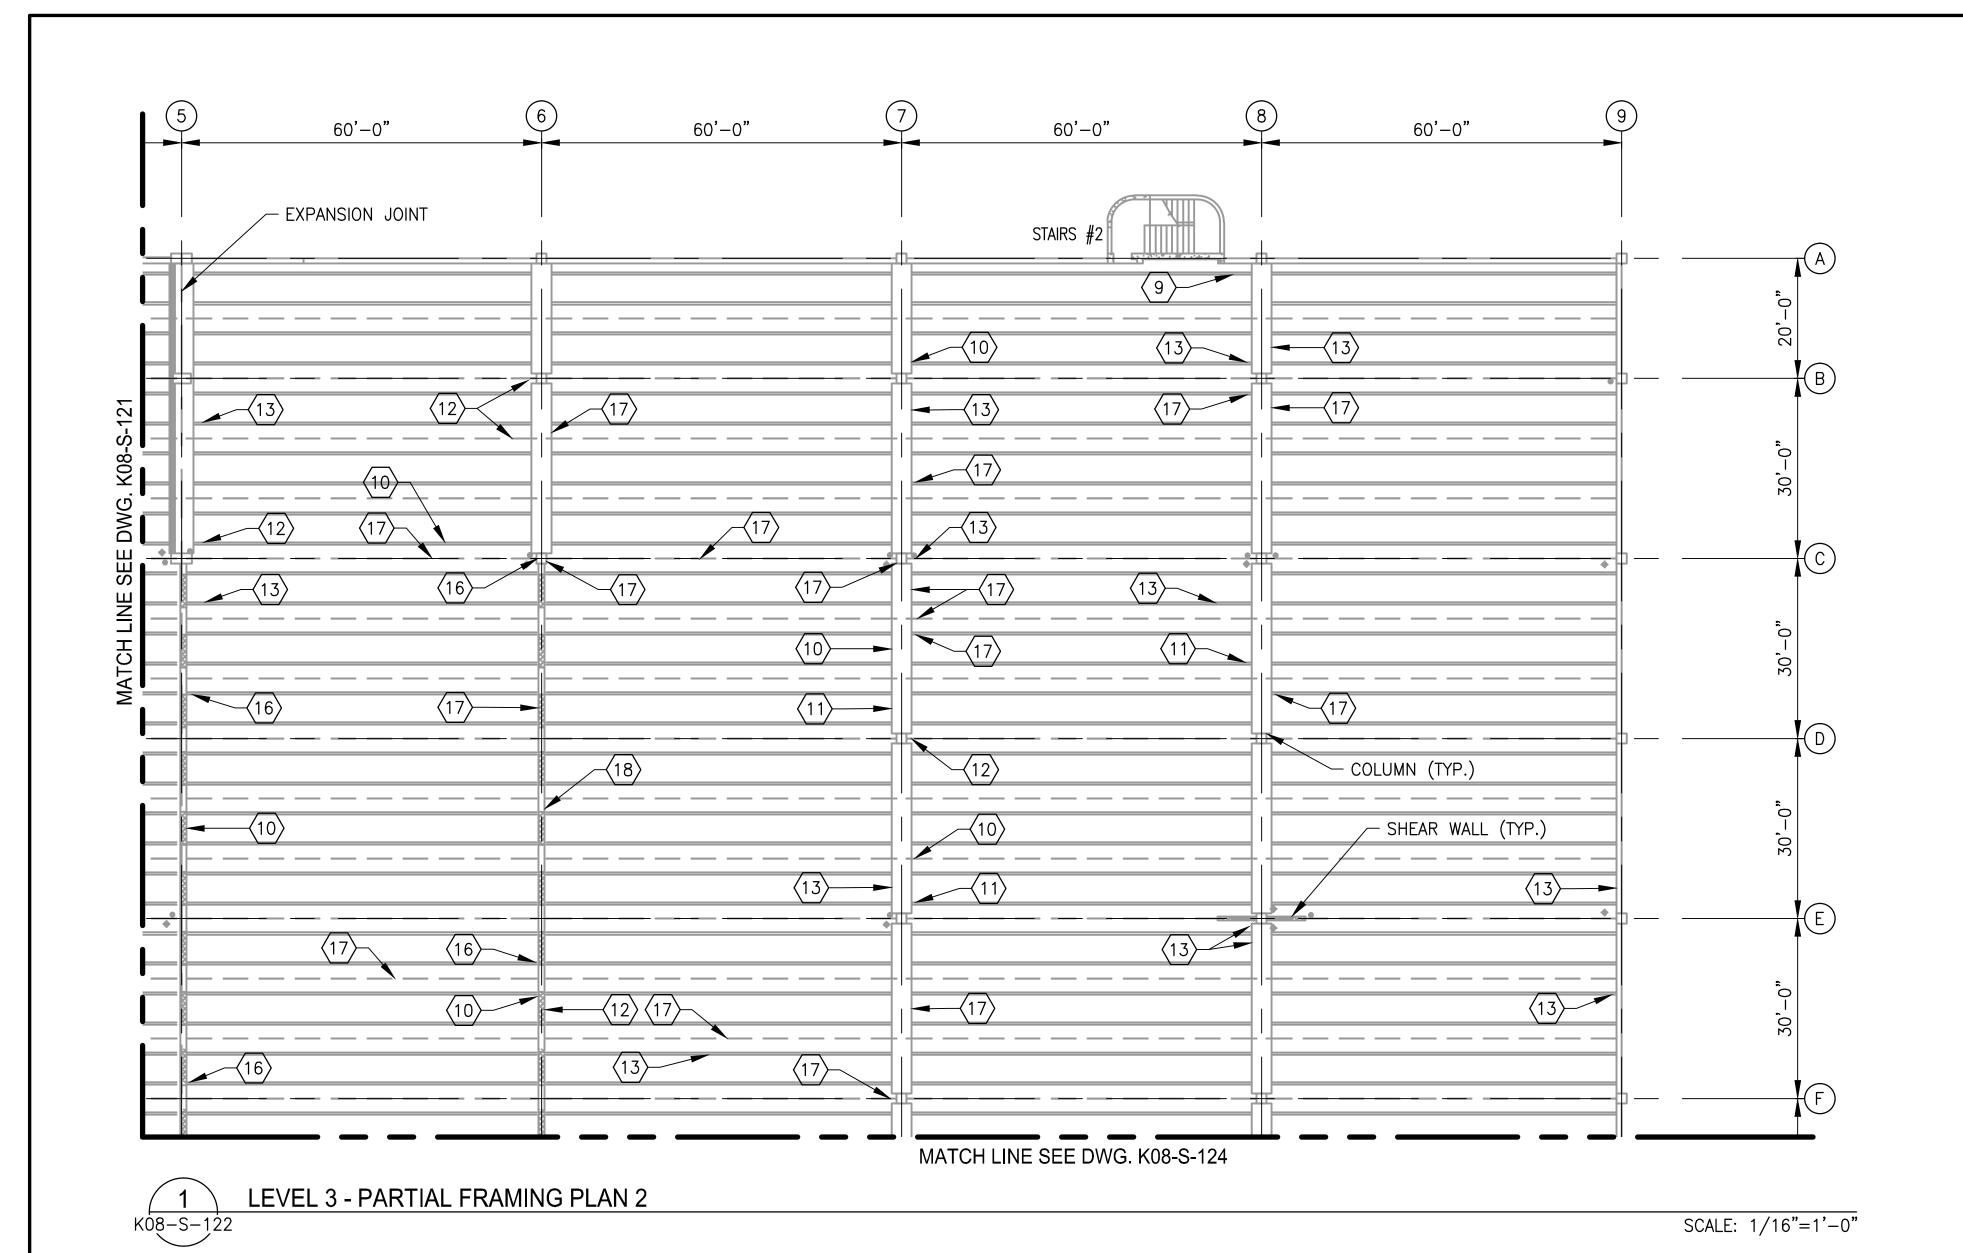

- 1. SEE DRAWING K08-S-002 FOR THE LIST OF KEY NOTES.
- 2. SEE DRAWING K08-S-121 FOR REPAIR QUANTITY TABLE ON THIS LEVEL.

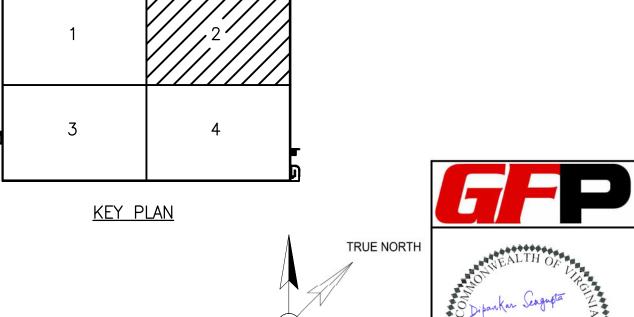

A Gannett Fleming/Parsons
JOINT VENTURE DIPANKAR SENGUPTA Lic. No. 0402043677

REHABILITATION OF PARKING GARAGES

K08 - VIENNA STATION - NORTH PARKING GARAGE

LEVEL 3

				REFERENCE DRAWINGS			REVISIONS	
DEGLONES	K. TSE	01/2018	NUMBER	TITLE	DATE	NUM	DESCRIPTION	
DESIGNED .	<u>K. 13L</u>	DATE			01/25/2018	0	FINAL SUBMITTAL	} "
DRAWN	A. PINKOWSKI	01/2018	'					_
DRAVIN <u>-</u>		DATE	'		<u> </u>			
CHECKED .	D. SENGUPTA	01/2018	\					_
		DATE	\					J AF
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WASHINGTON METROPOLITAN AREA TRANSIT AUTHORITY OFFICE OF THE CHIEF OPERATING OFFICER IRPG - FIXED FACILITIES APPROVED


JOHN PURDY
ENGINEERING MANAGER 01/25/2018


DIPANKAR SENGUPTA ENGINEER OF RECORD


PARTIAL FRAMING PLAN 2 DRAWING NO. CONTRACT NO. SCALE FQ18064

PLAN NORTH

SHEET NO. 1/16"=1'-0" K08-S-122 408 of 503

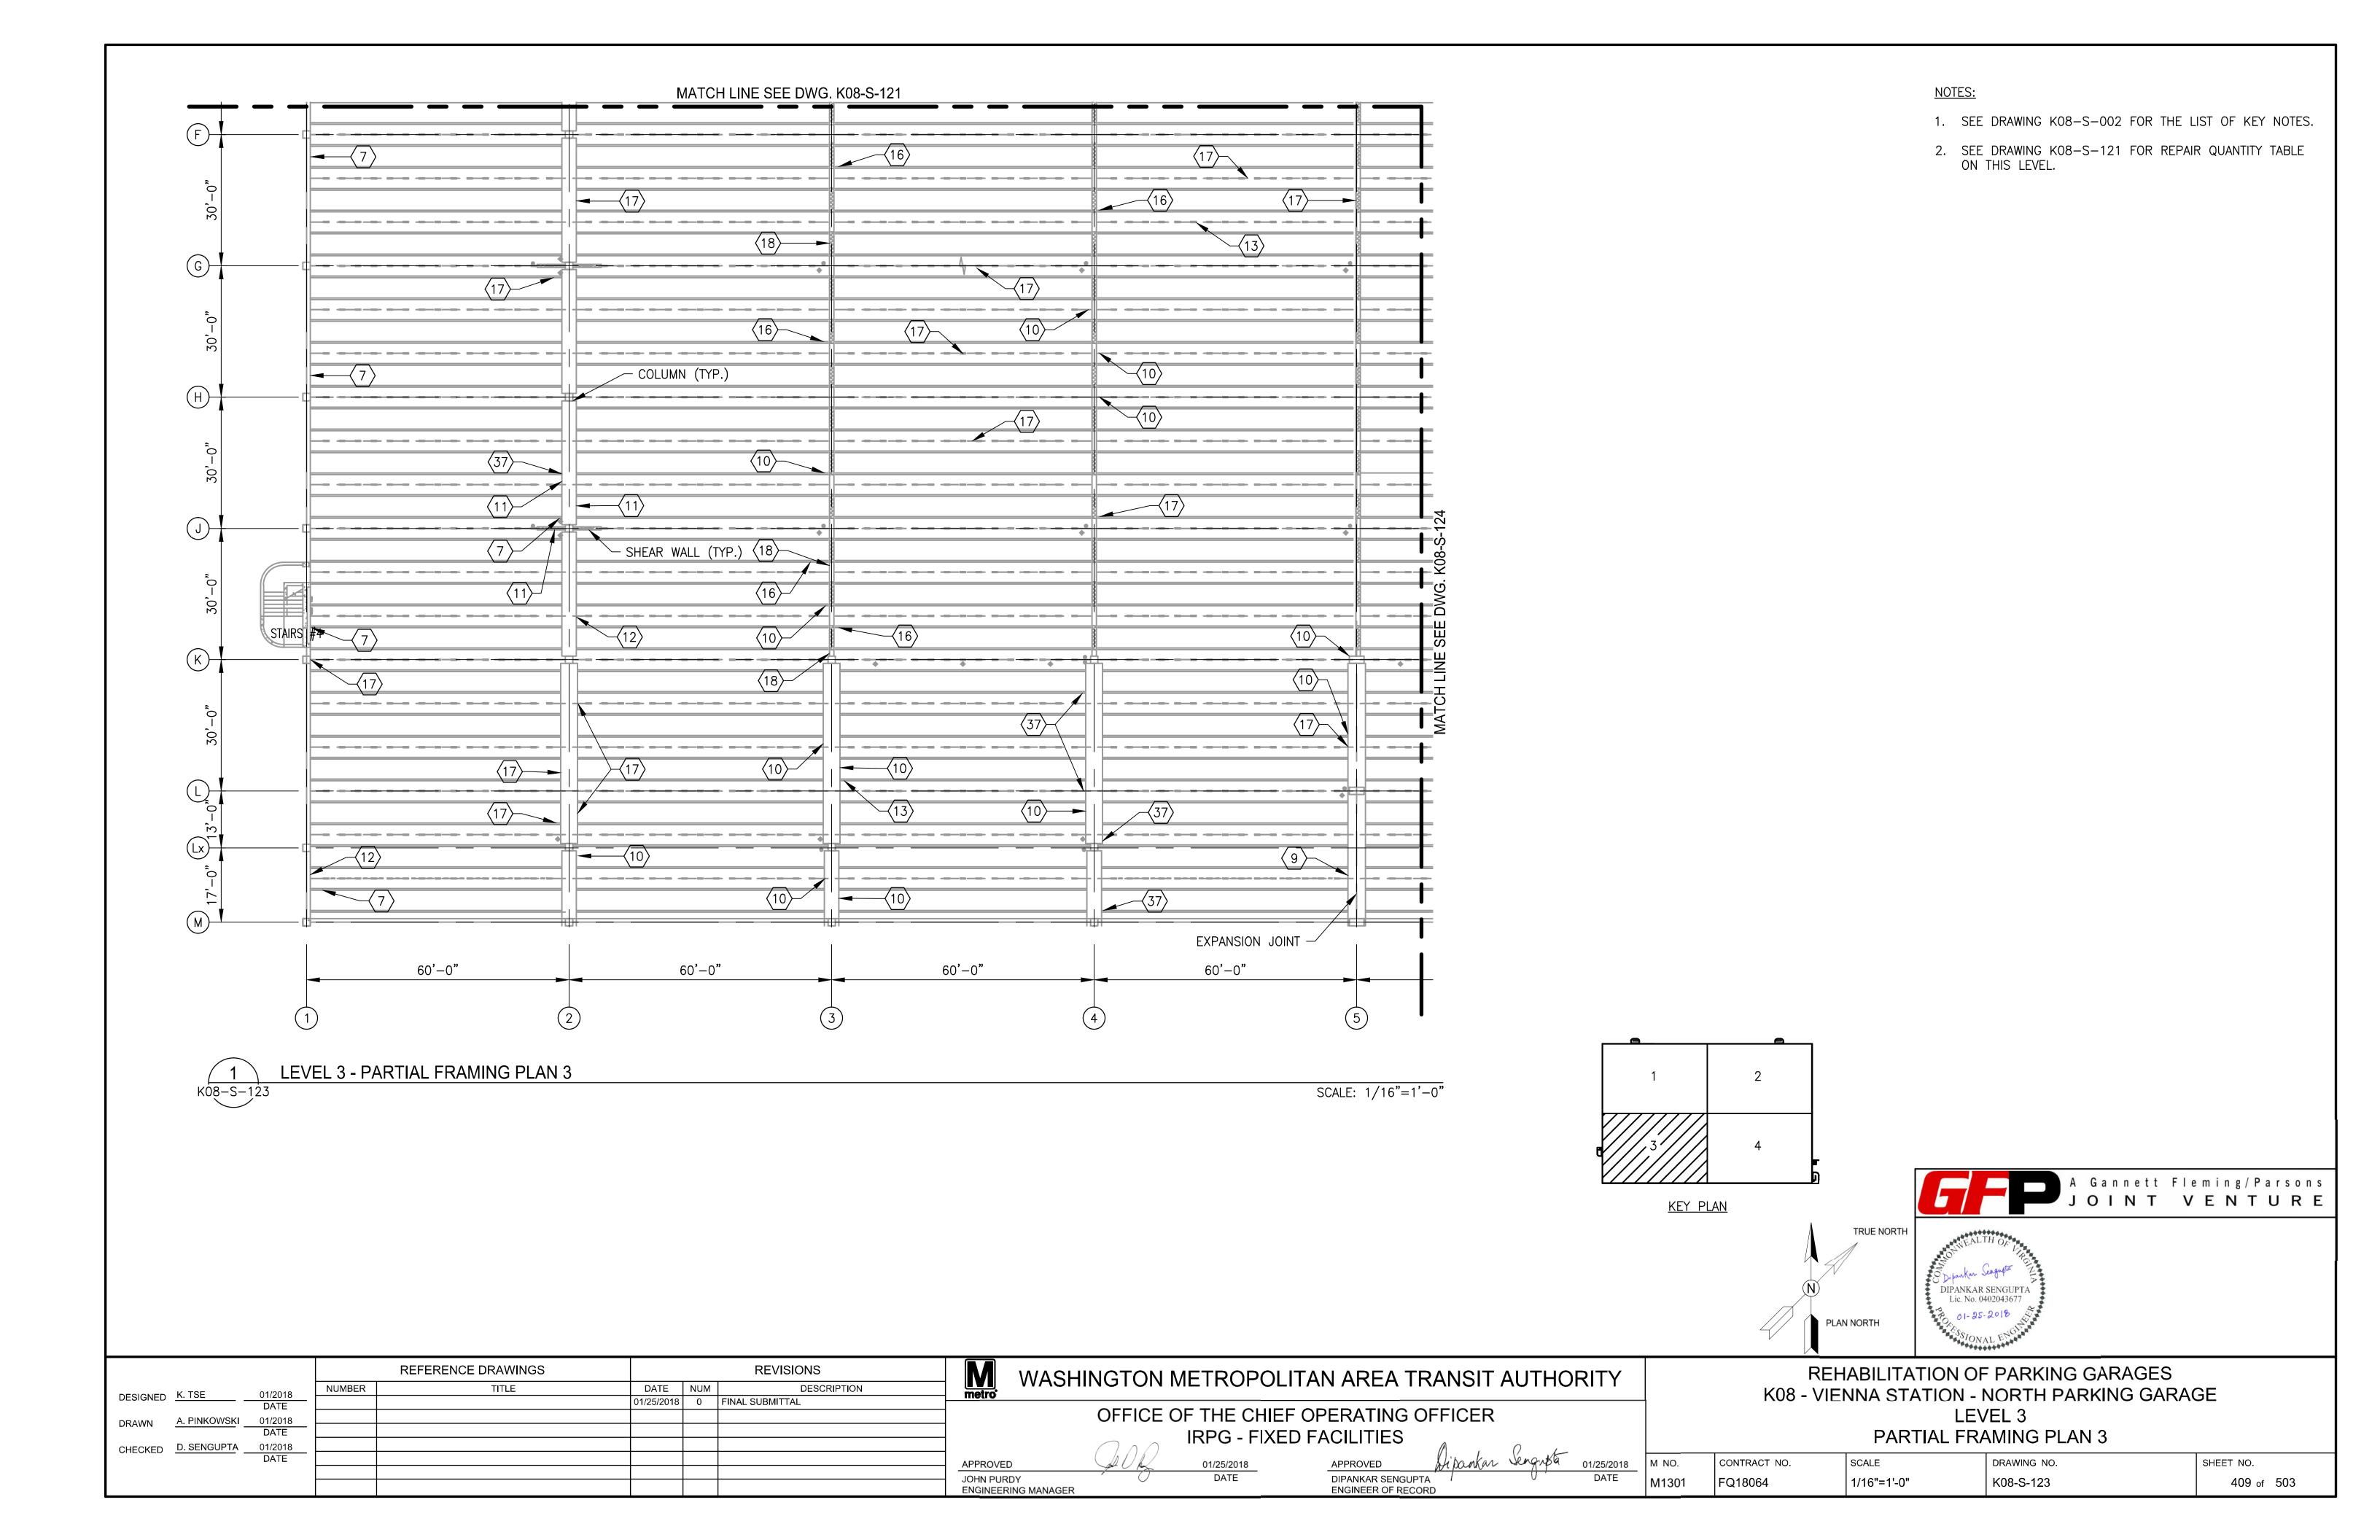

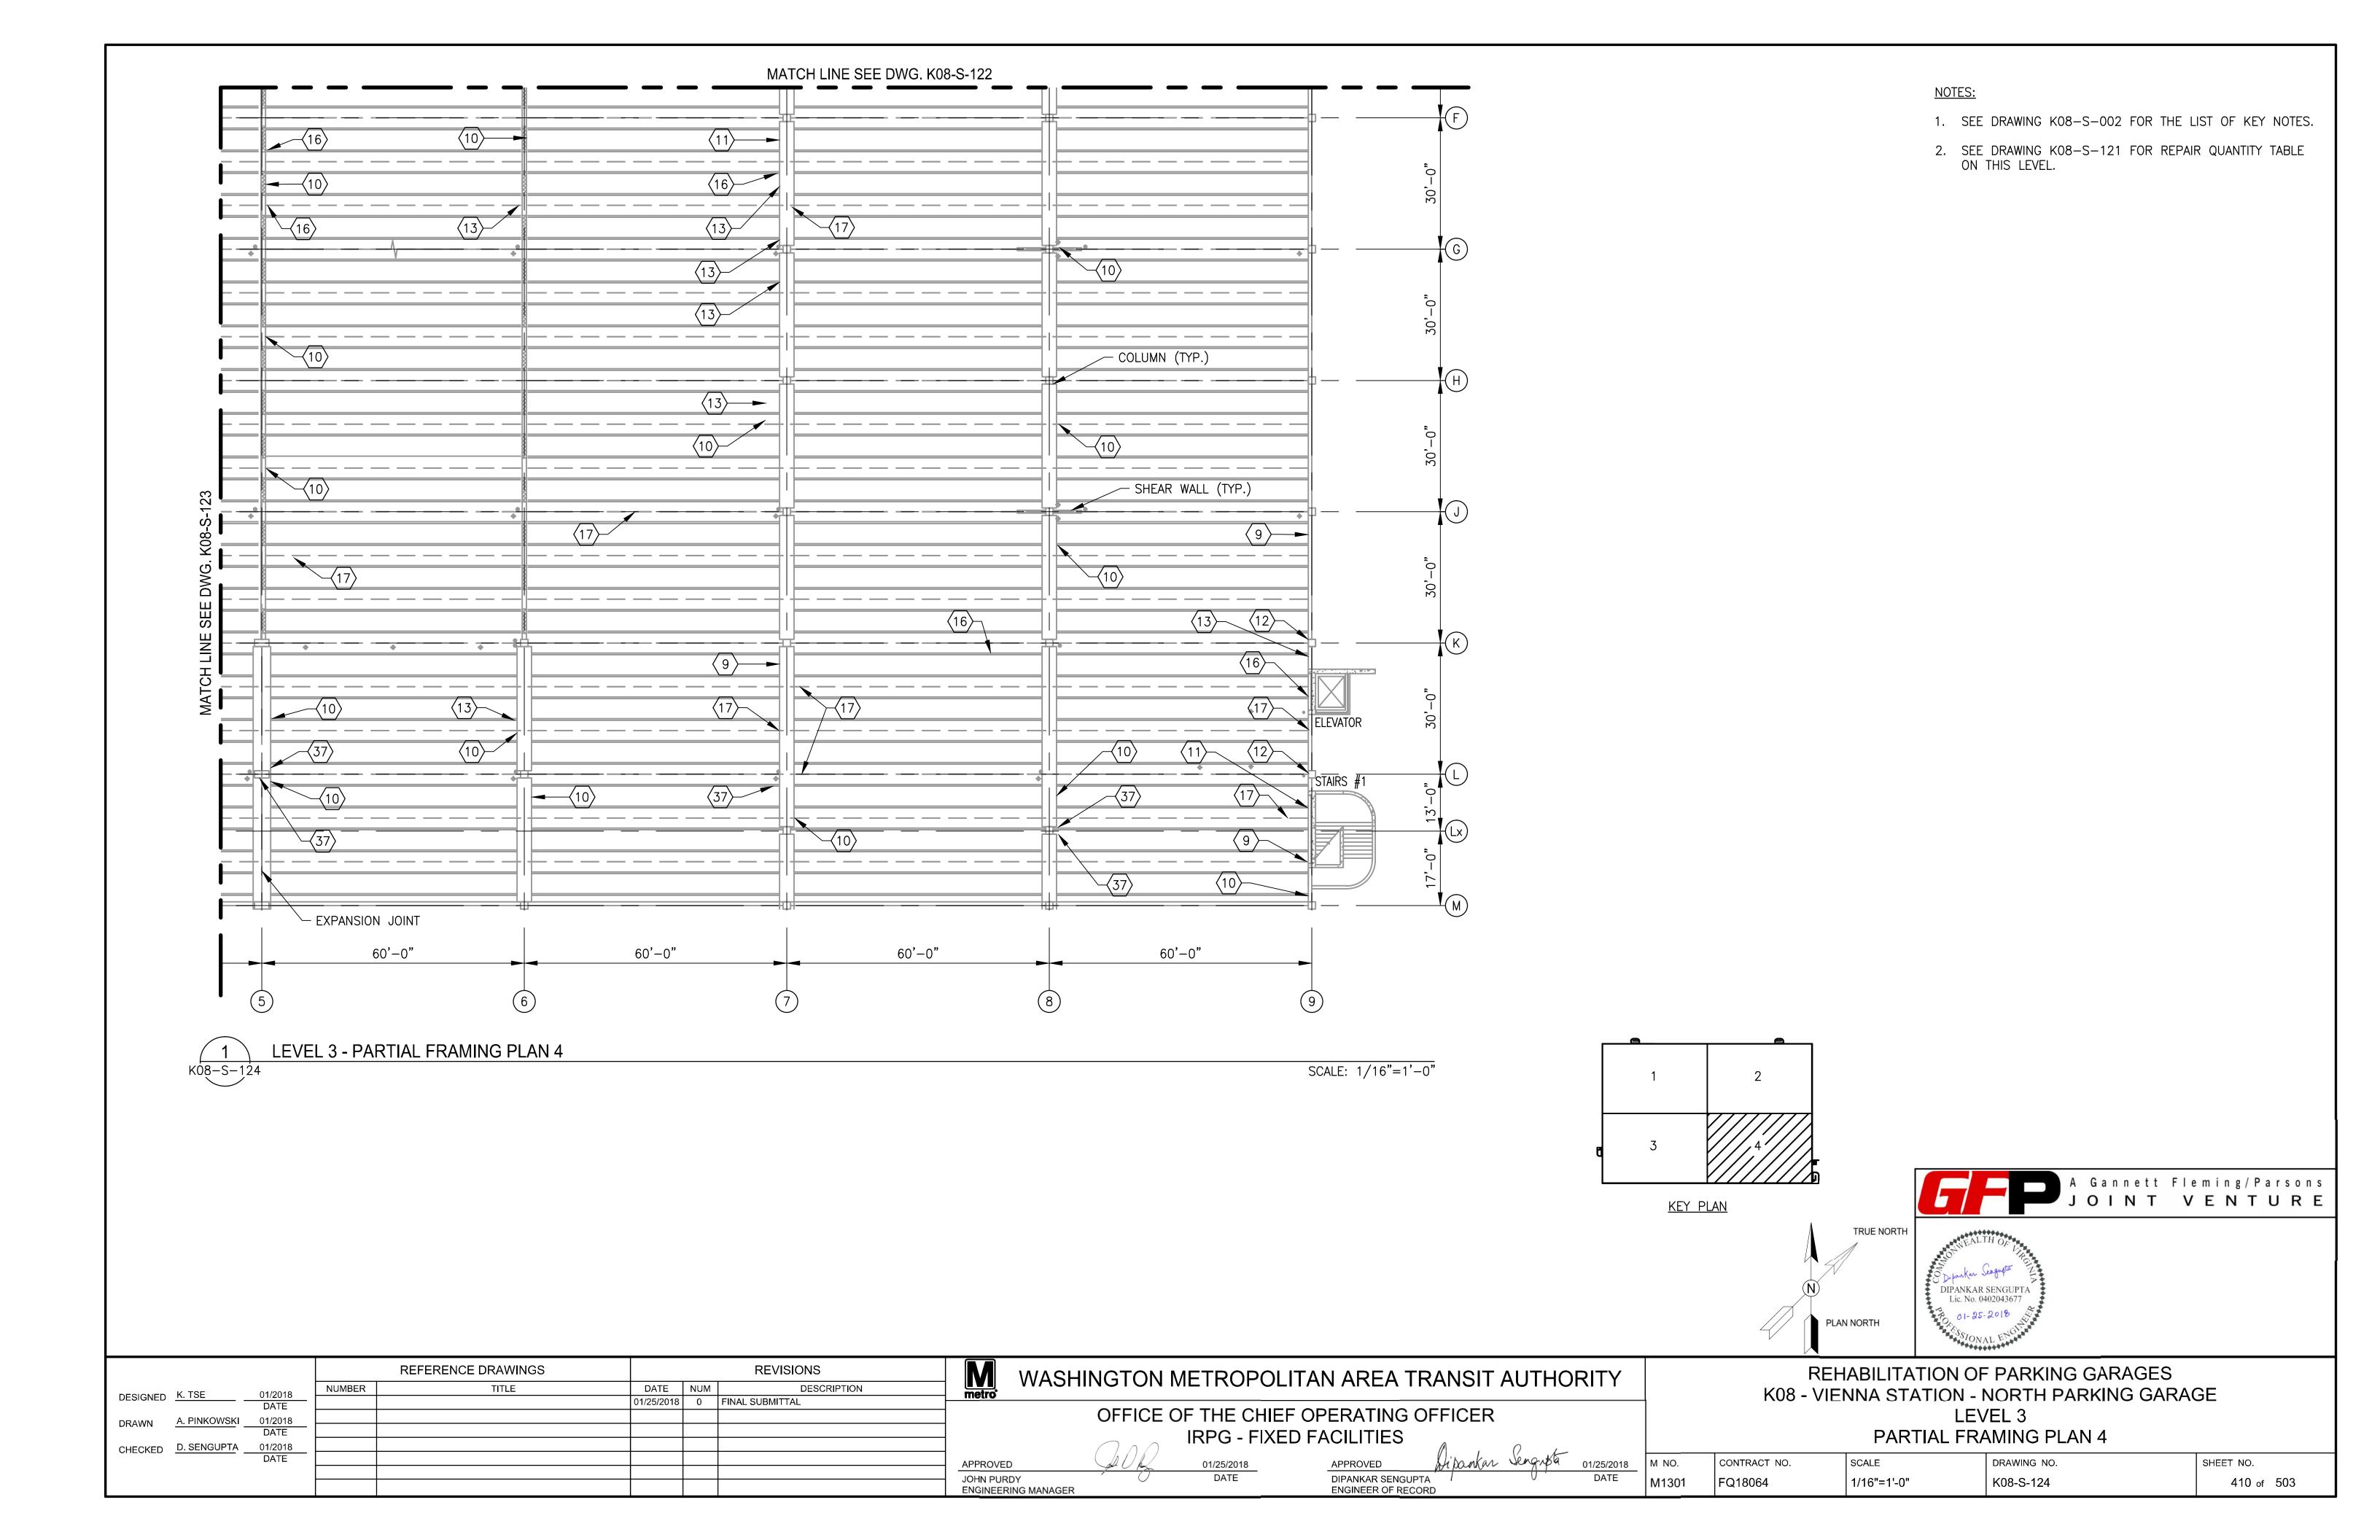


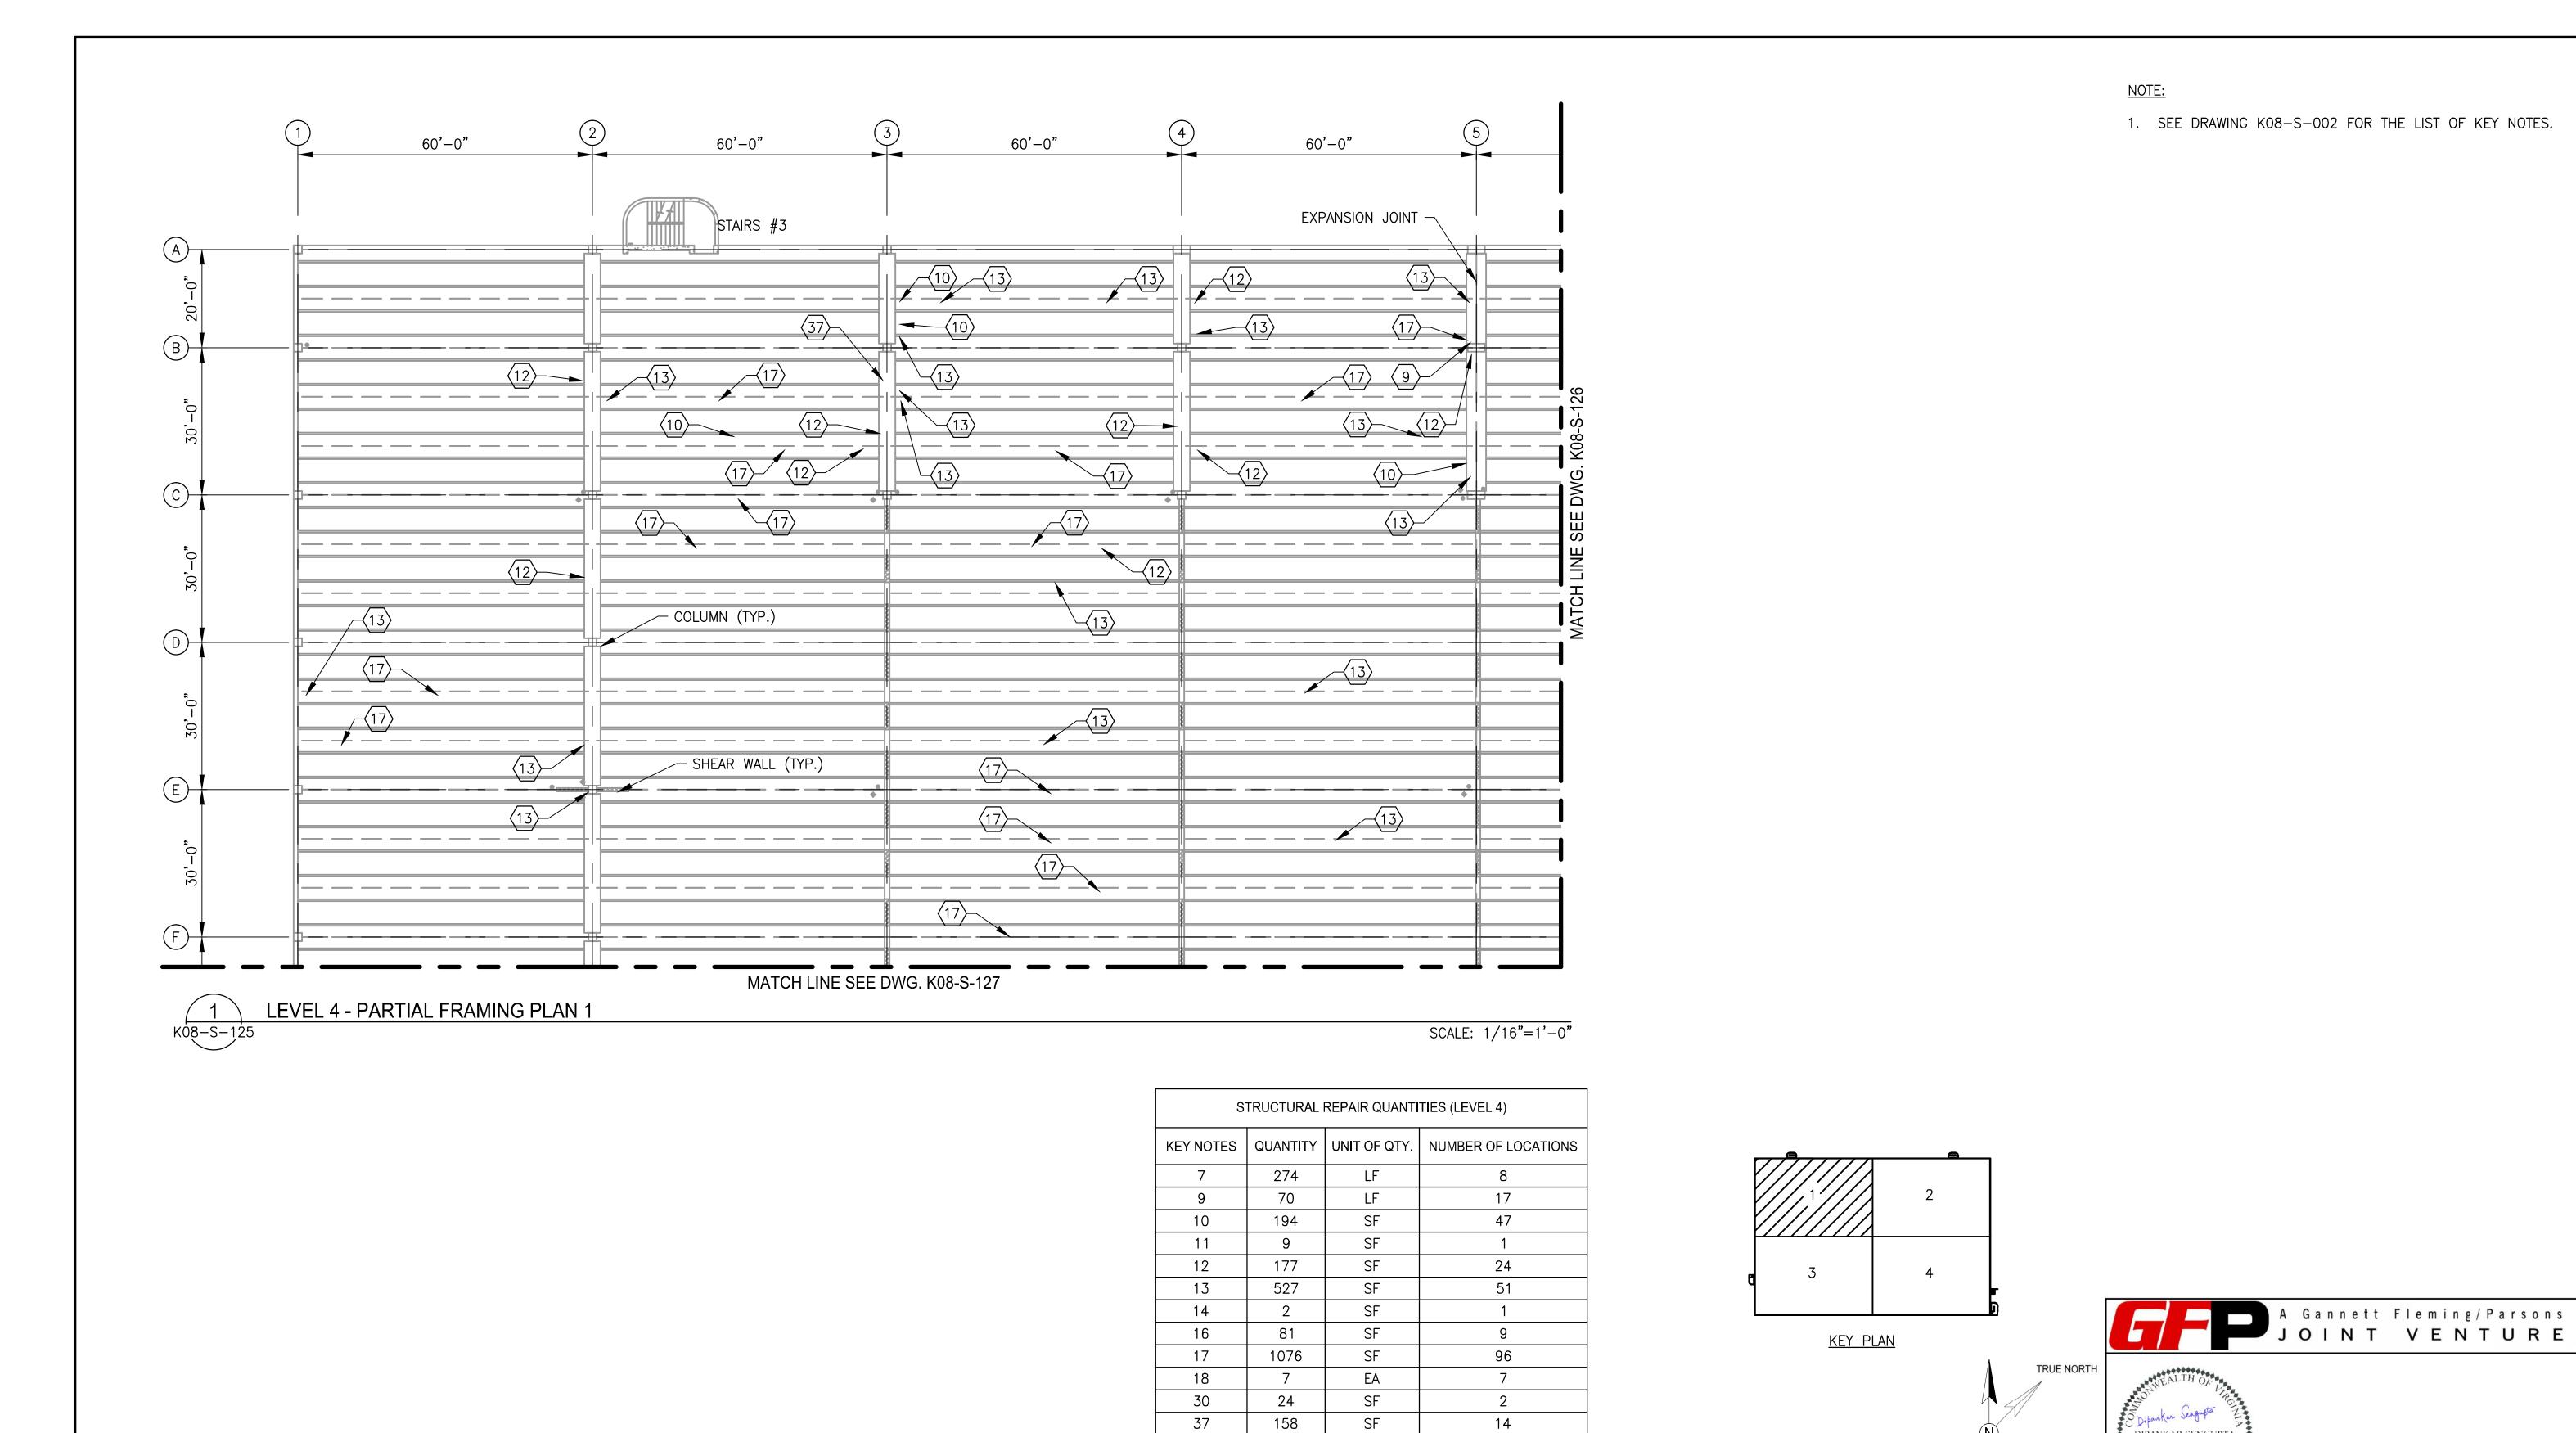


	REFERENCE DRAWINGS		REVISIONS	M WASHINGTON METROPOLITAN AREA TRANSIT AUTHORITY		REHABILITATION OF PARKING GARAGES				
DESIGNED <u>K. TSE</u> 01/2018	NUMBER TITLE	DATE NUM 01/25/2018 0	DESCRIPTION FINAL SUBMITTAL	metro:		K08 - VIENNA STATION - NORTH PARKING GARAGE				
DATE		01/23/2010	TINAL SUDWITTAL	OFFICE OF THE CHIEF OPER IRPG - FIXED FACI		LEVEL 4 PARTIAL FRAMING PLAN 1				
DATE				JOHN PURDY DATE DIPA	PROVED GIVEN SENGUPTA DATE GINEER OF RECORD	м NO. М1301	CONTRACT NO. FQ18064	SCALE 1/16"=1'-0"	DRAWING NO. K08-S-125	SHEET NO. 411 of 503

DIPANKAR SENGUPTA Lic. No. 0402043677


PLAN NORTH

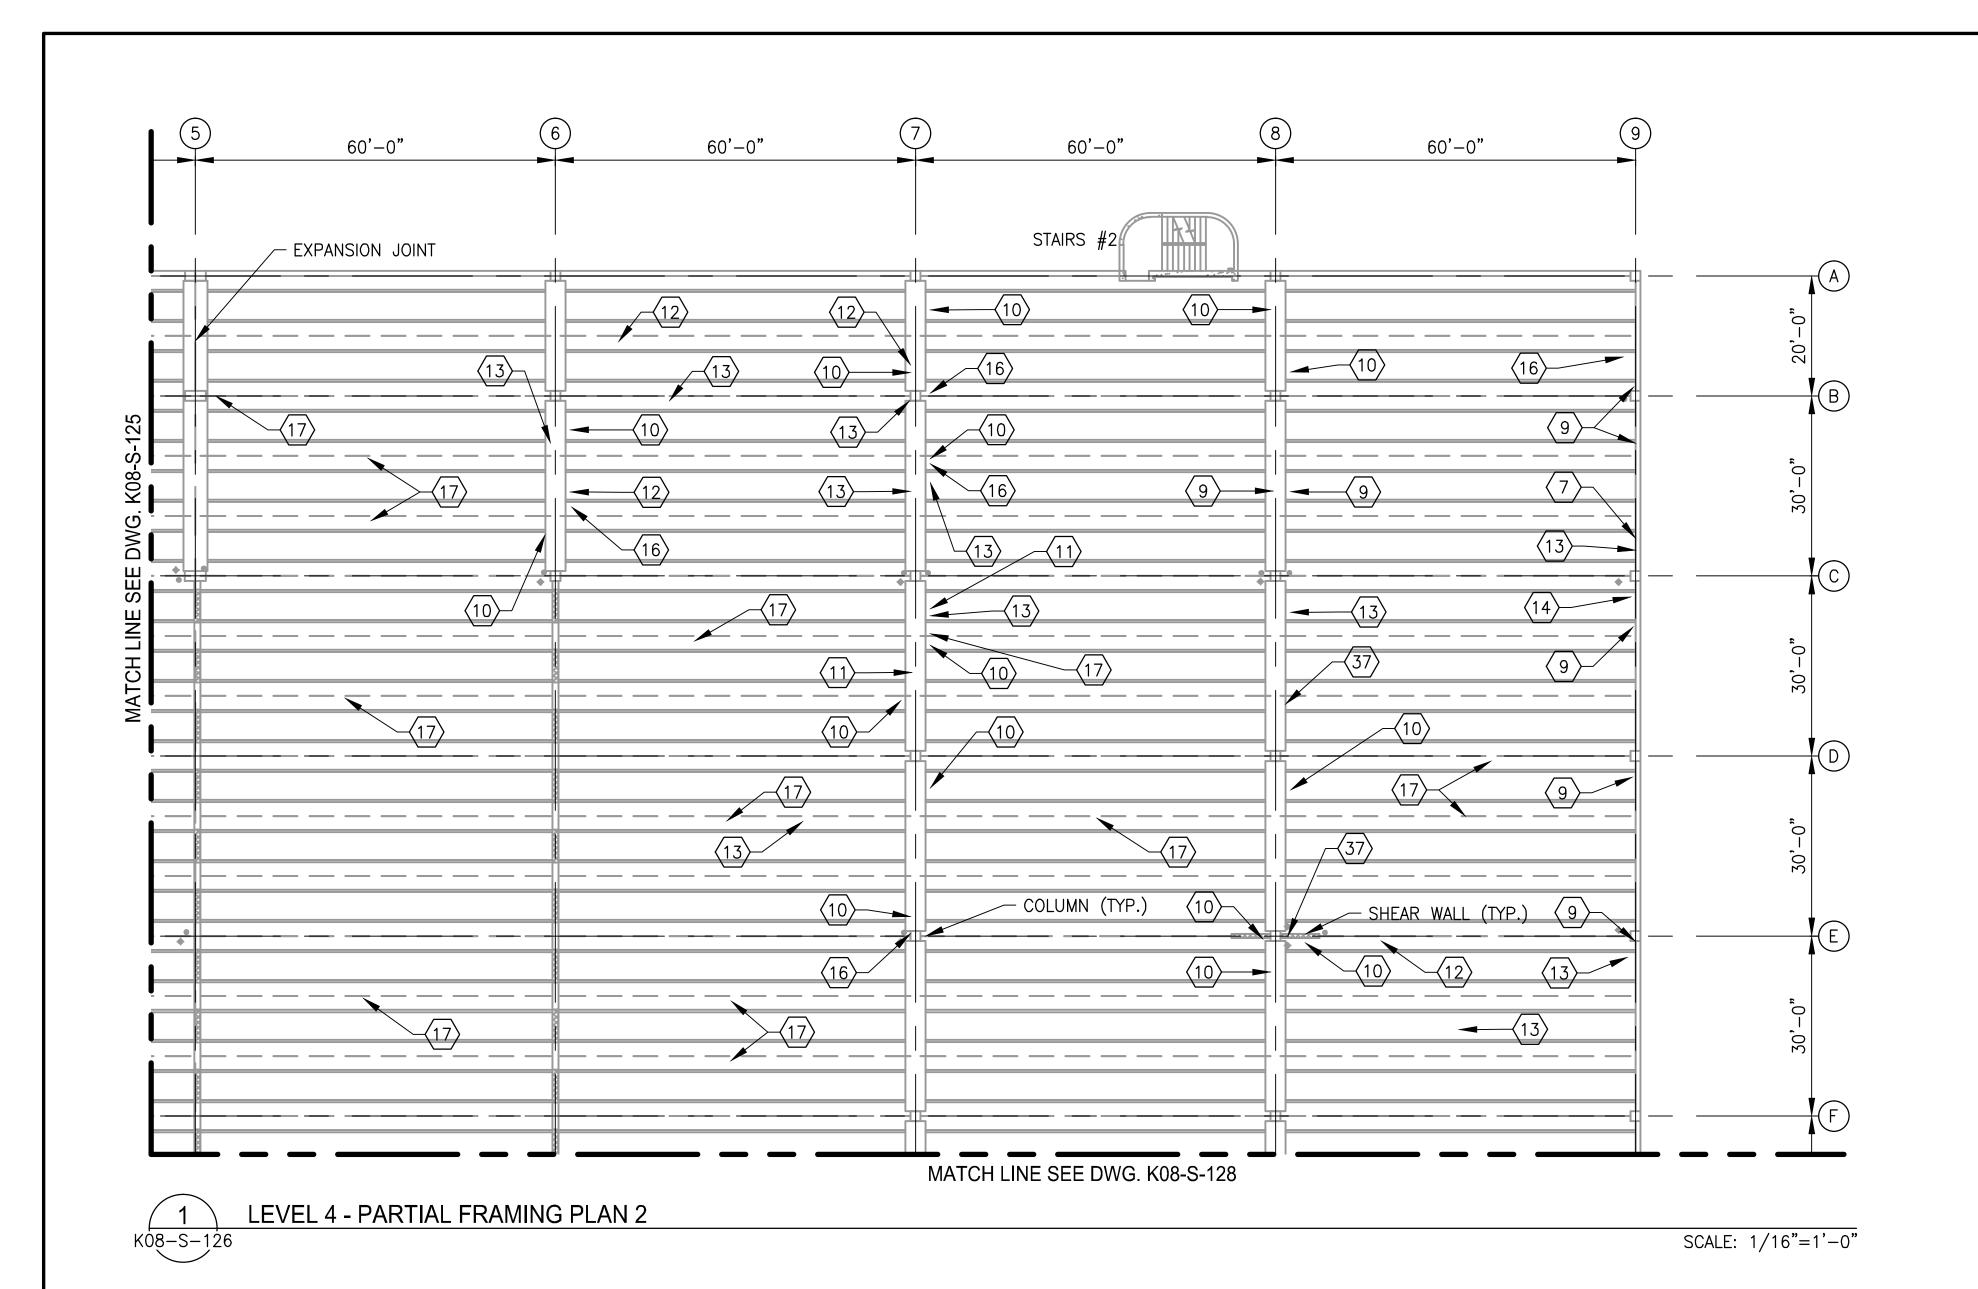



- 1. SEE DRAWING K08-S-002 FOR THE LIST OF KEY NOTES.
- 2. SEE DRAWING K08-S-125 FOR REPAIR QUANTITY TABLE ON THIS LEVEL.

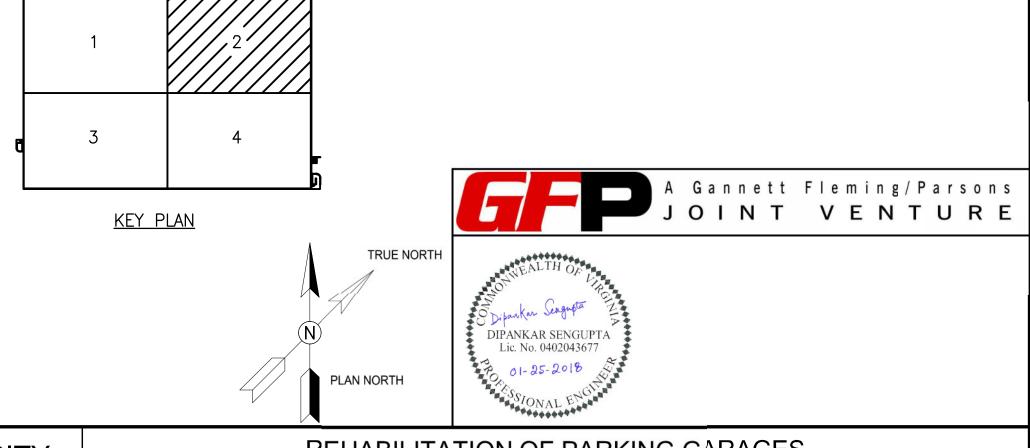


IV TOE 04/0040	REFERENCE DRAWINGS NUMBER TITLE DATE NUI	REVISIONS M DESCRIPTION	WASHINGTON METROPOLITAN AREA TRANSIT AUTHORITY REHABILITATION OF PARKING GARAGES
DESIGNED K. TSE 01/2018 DATE DRAWN A. PINKOWSKI 01/2018 DATE	01/25/2018 0	FINAL SUBMITTAL	Metro: OFFICE OF THE CHIEF OPERATING OFFICER IRPG - FIXED FACILITIES PARTIAL FRAMING PLAN 2
CHECKED D. SENGUPTA 01/2018 DATE			APPROVED O1/25/2018 JOHN PURDY ENGINEERING MANAGER APPROVED O1/25/2018 DATE APPROVED APPROVED APPROVED O1/25/2018 DIPANKAR SENGUPTA ENGINEER OF RECORD APPROVED O1/25/2018 DATE O1/25/2018 DATE O1/25/2018 M NO. CONTRACT NO. SCALE ORAWING NO. K08-S-126 APPROVED APPROVED O1/25/2018 DATE O1/25/2018 M NO. FQ18064 O1/16"=1'-0" K08-S-126

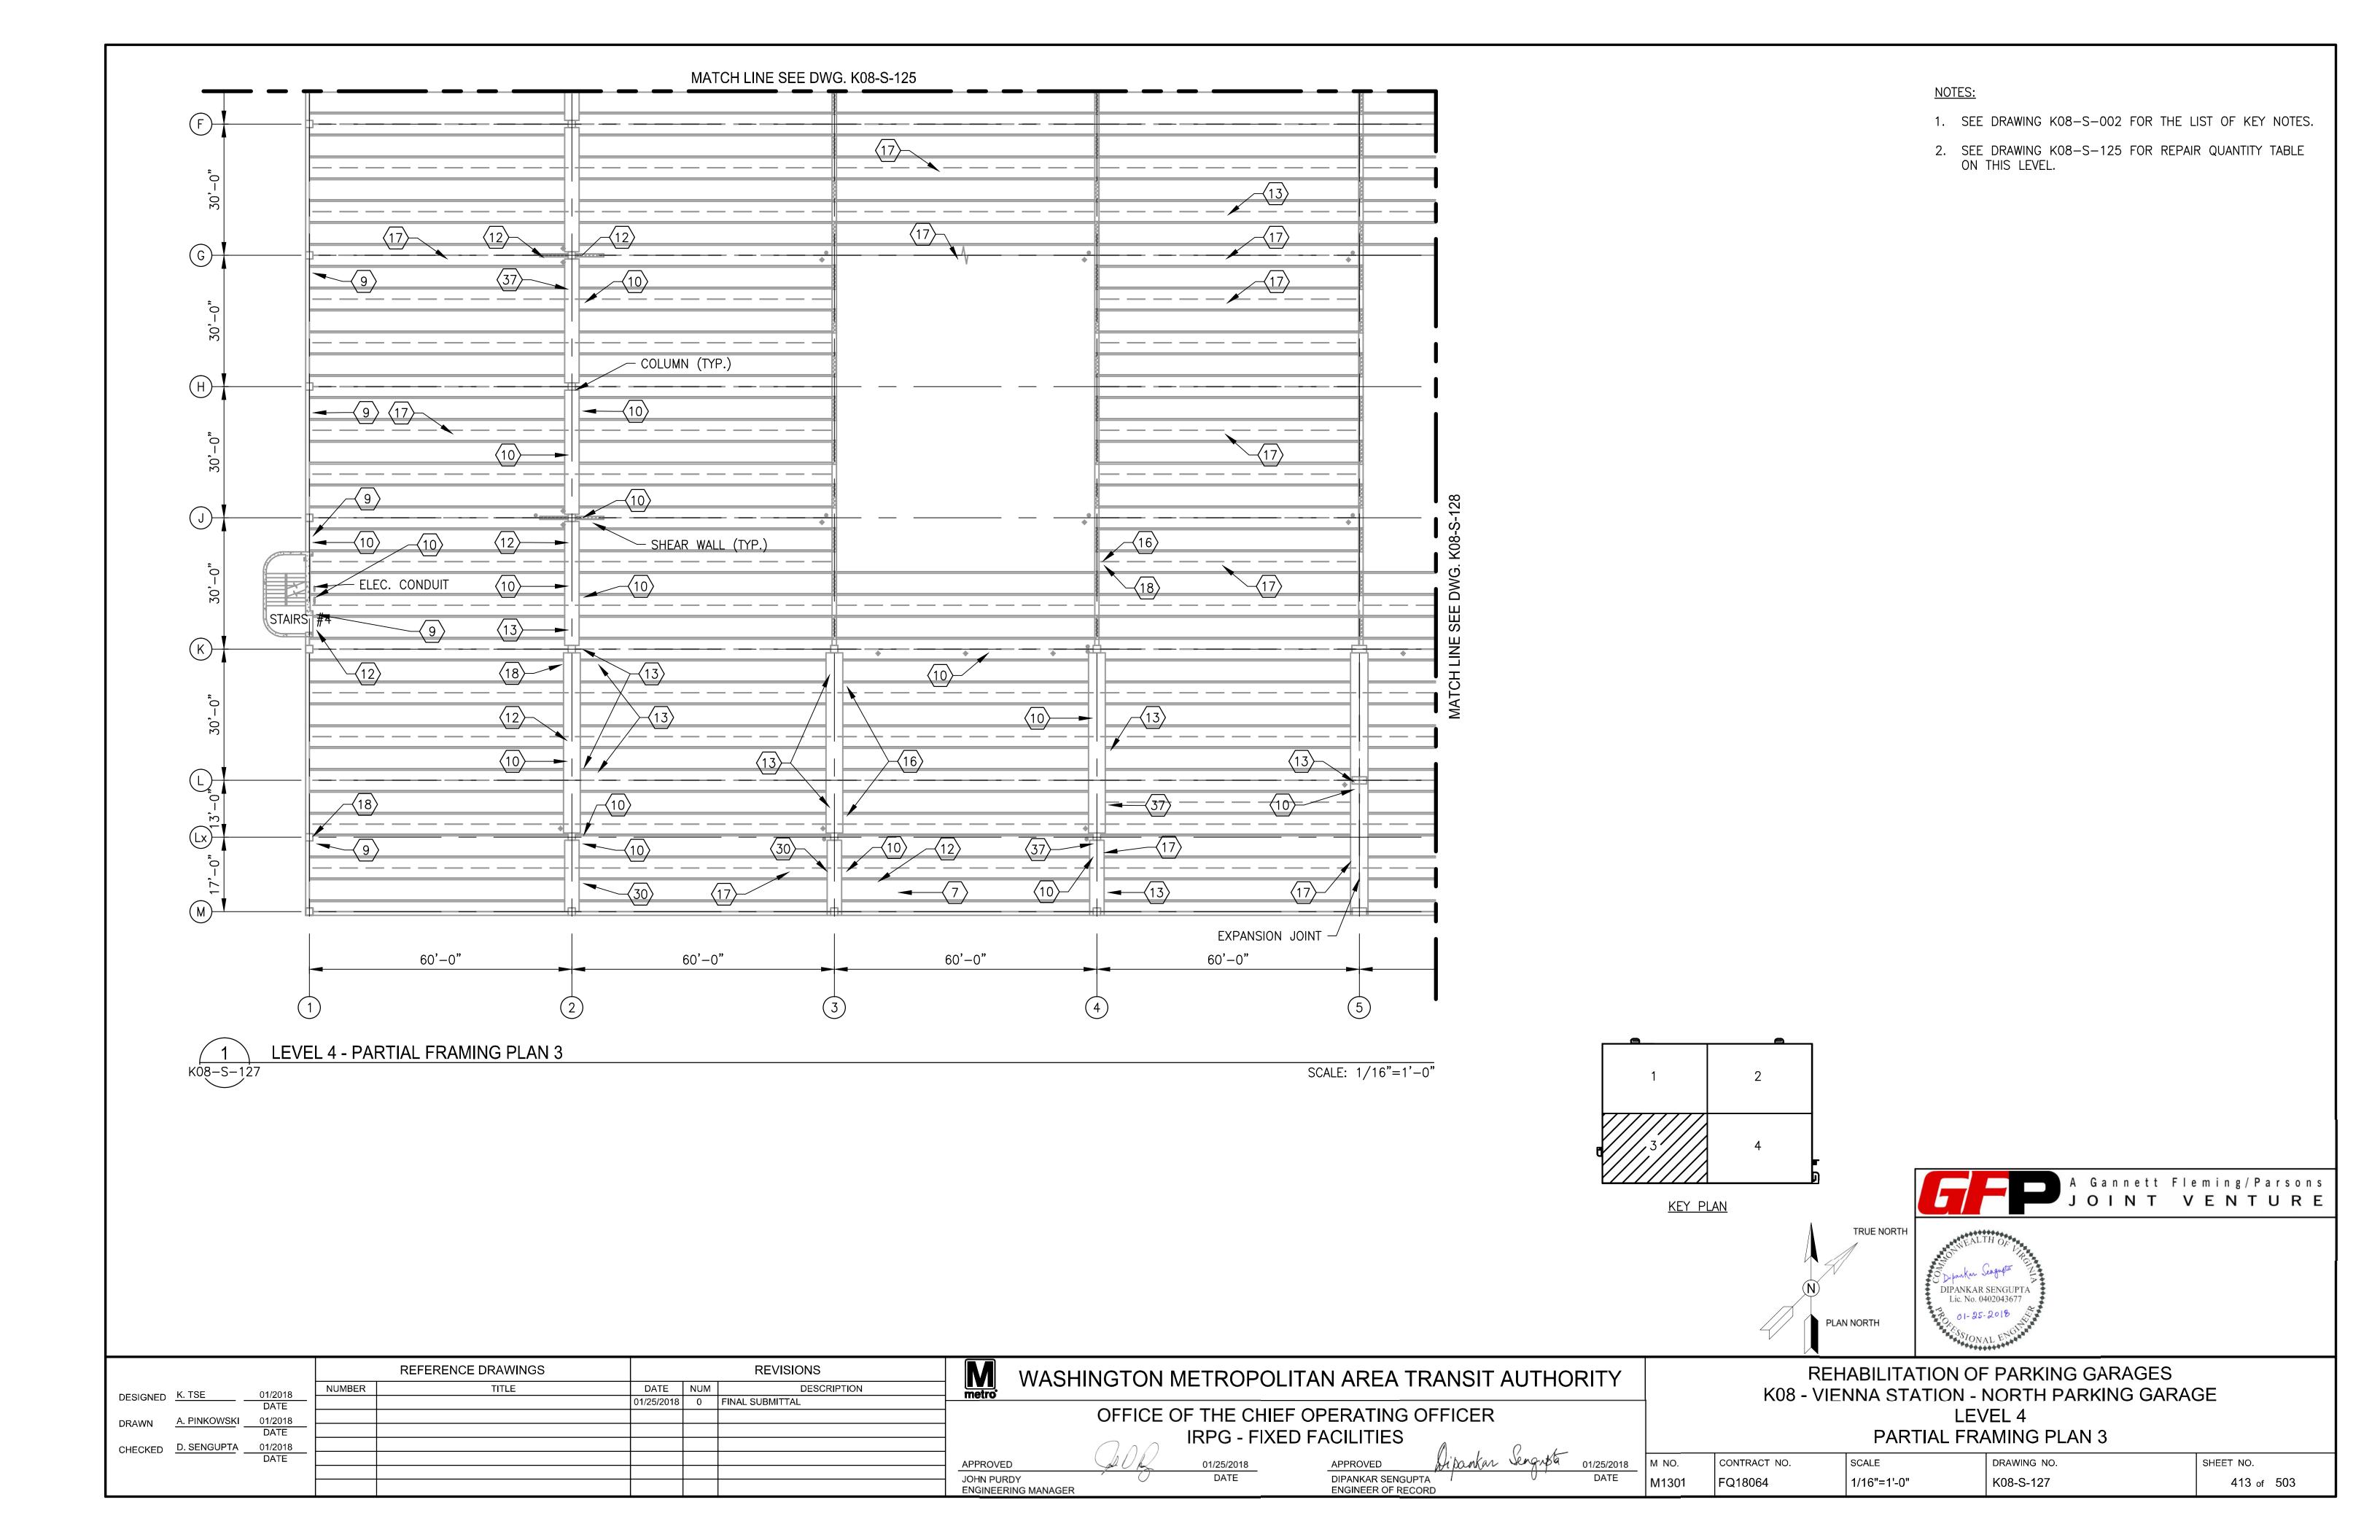

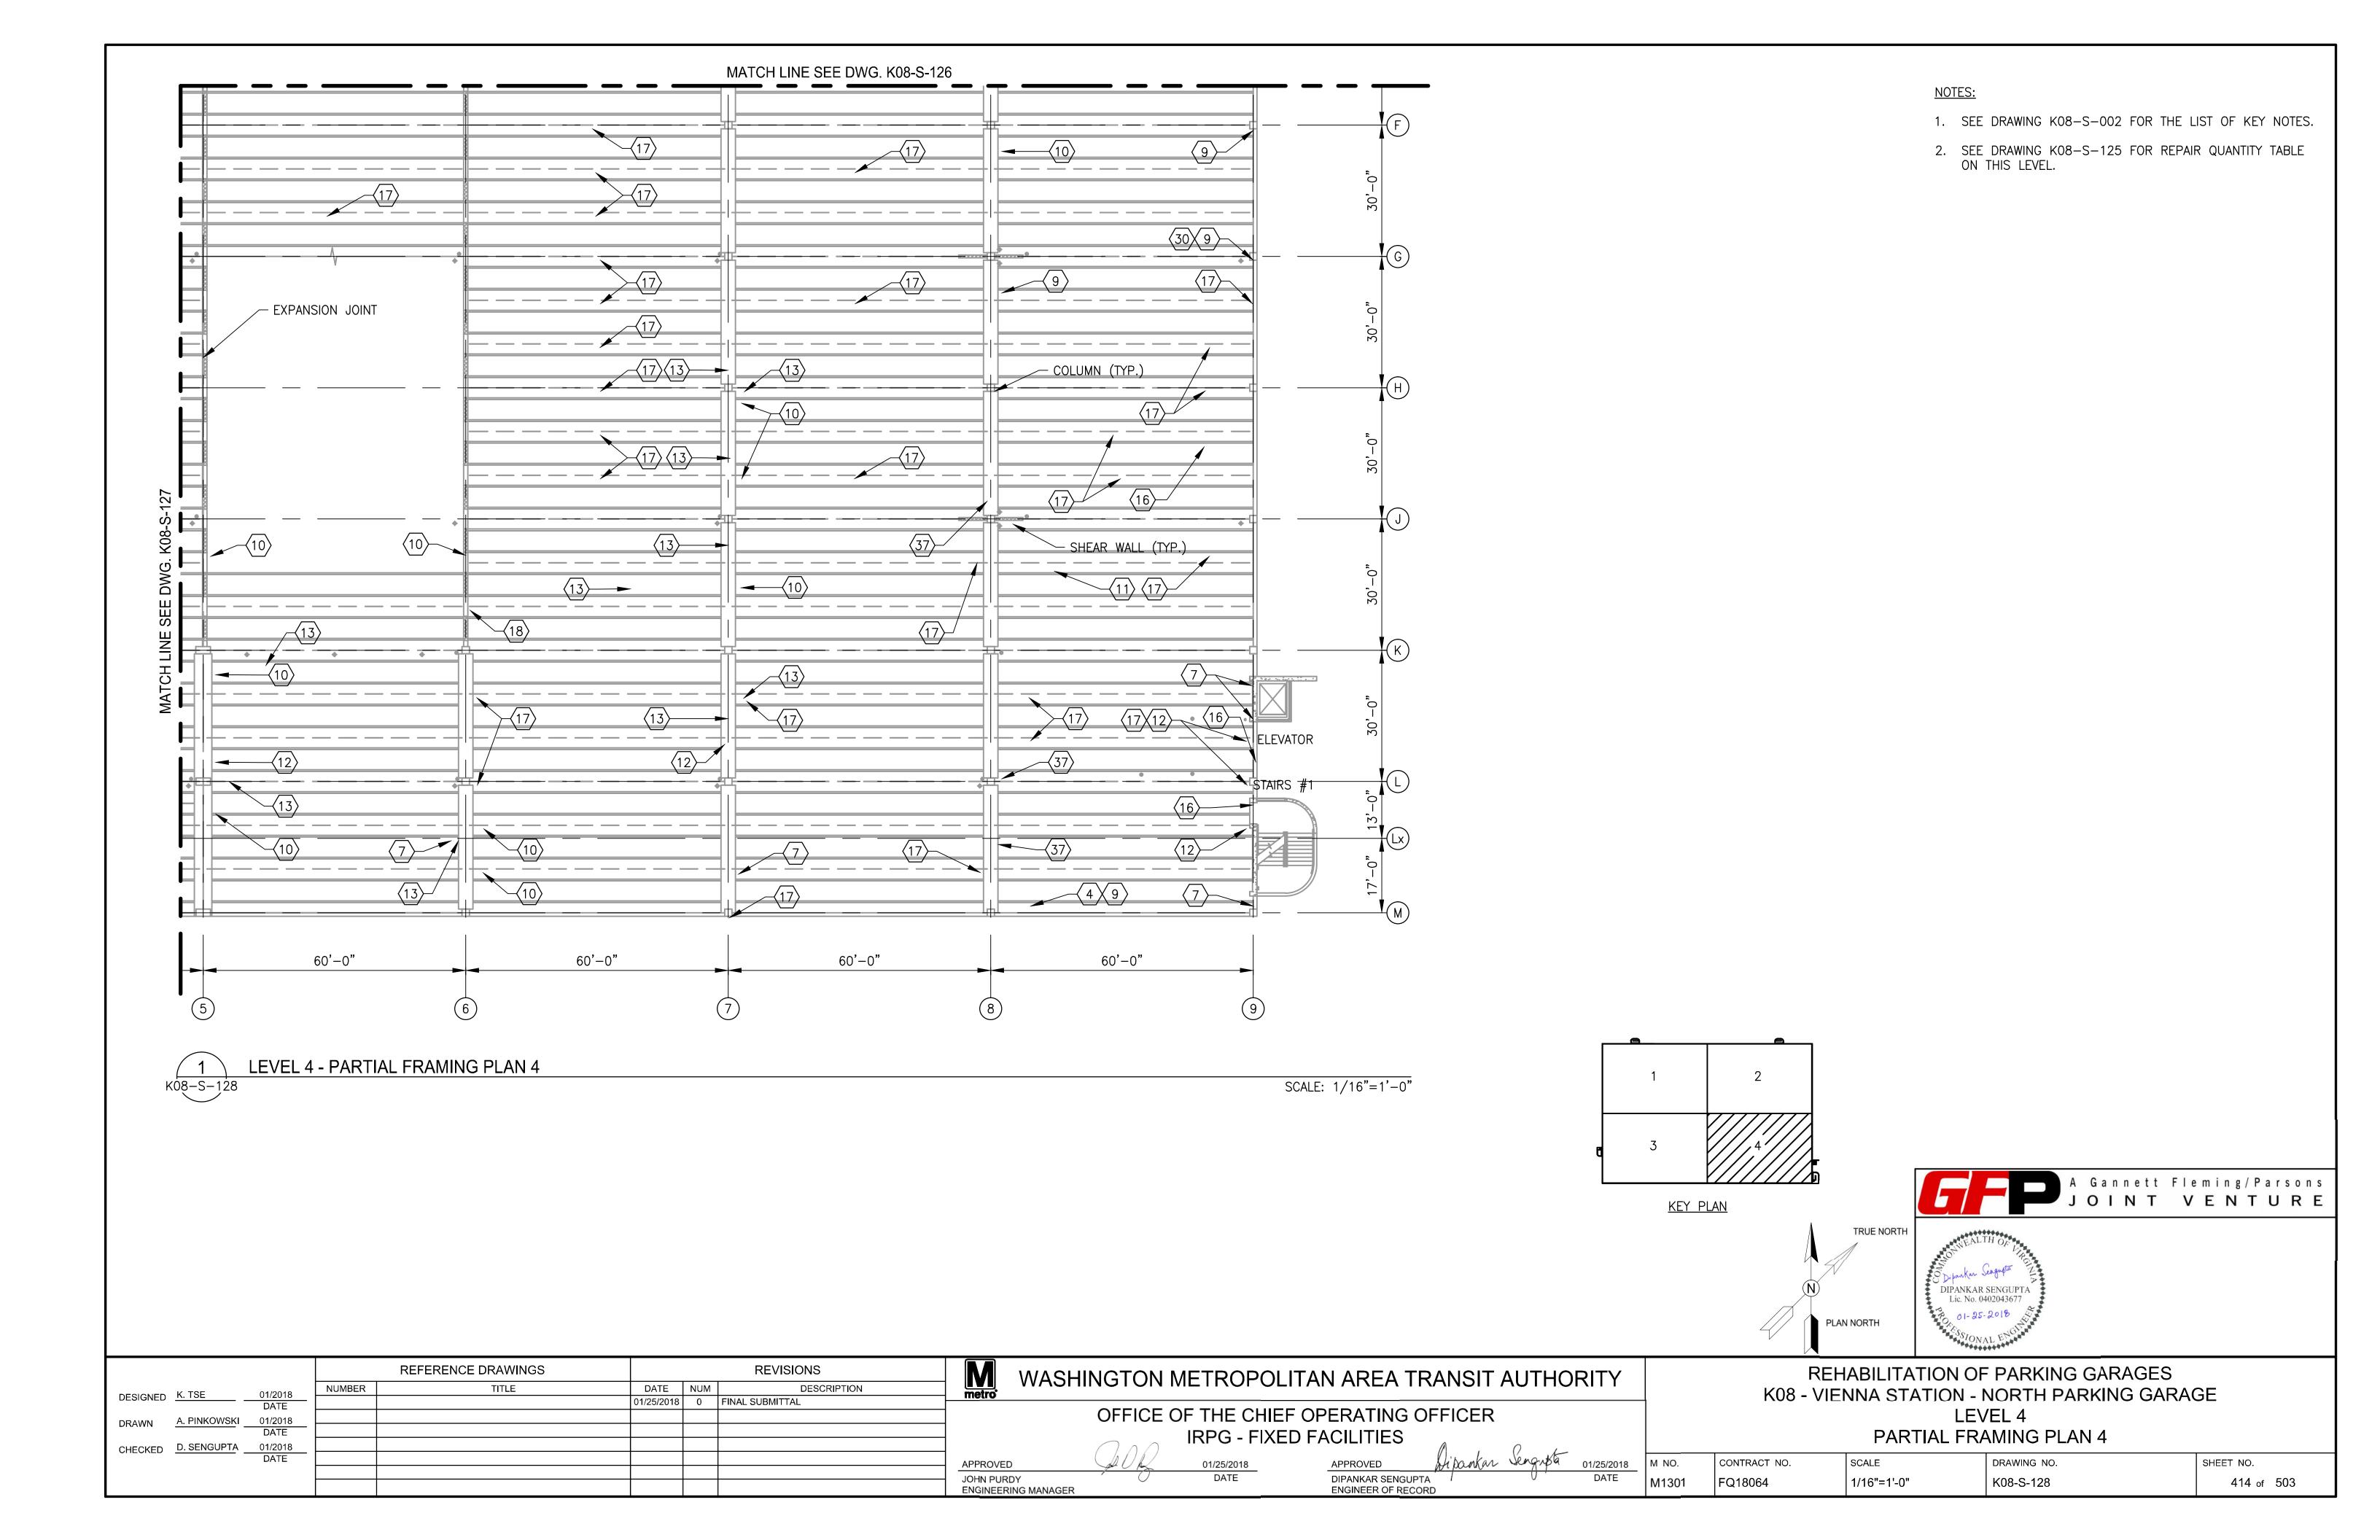

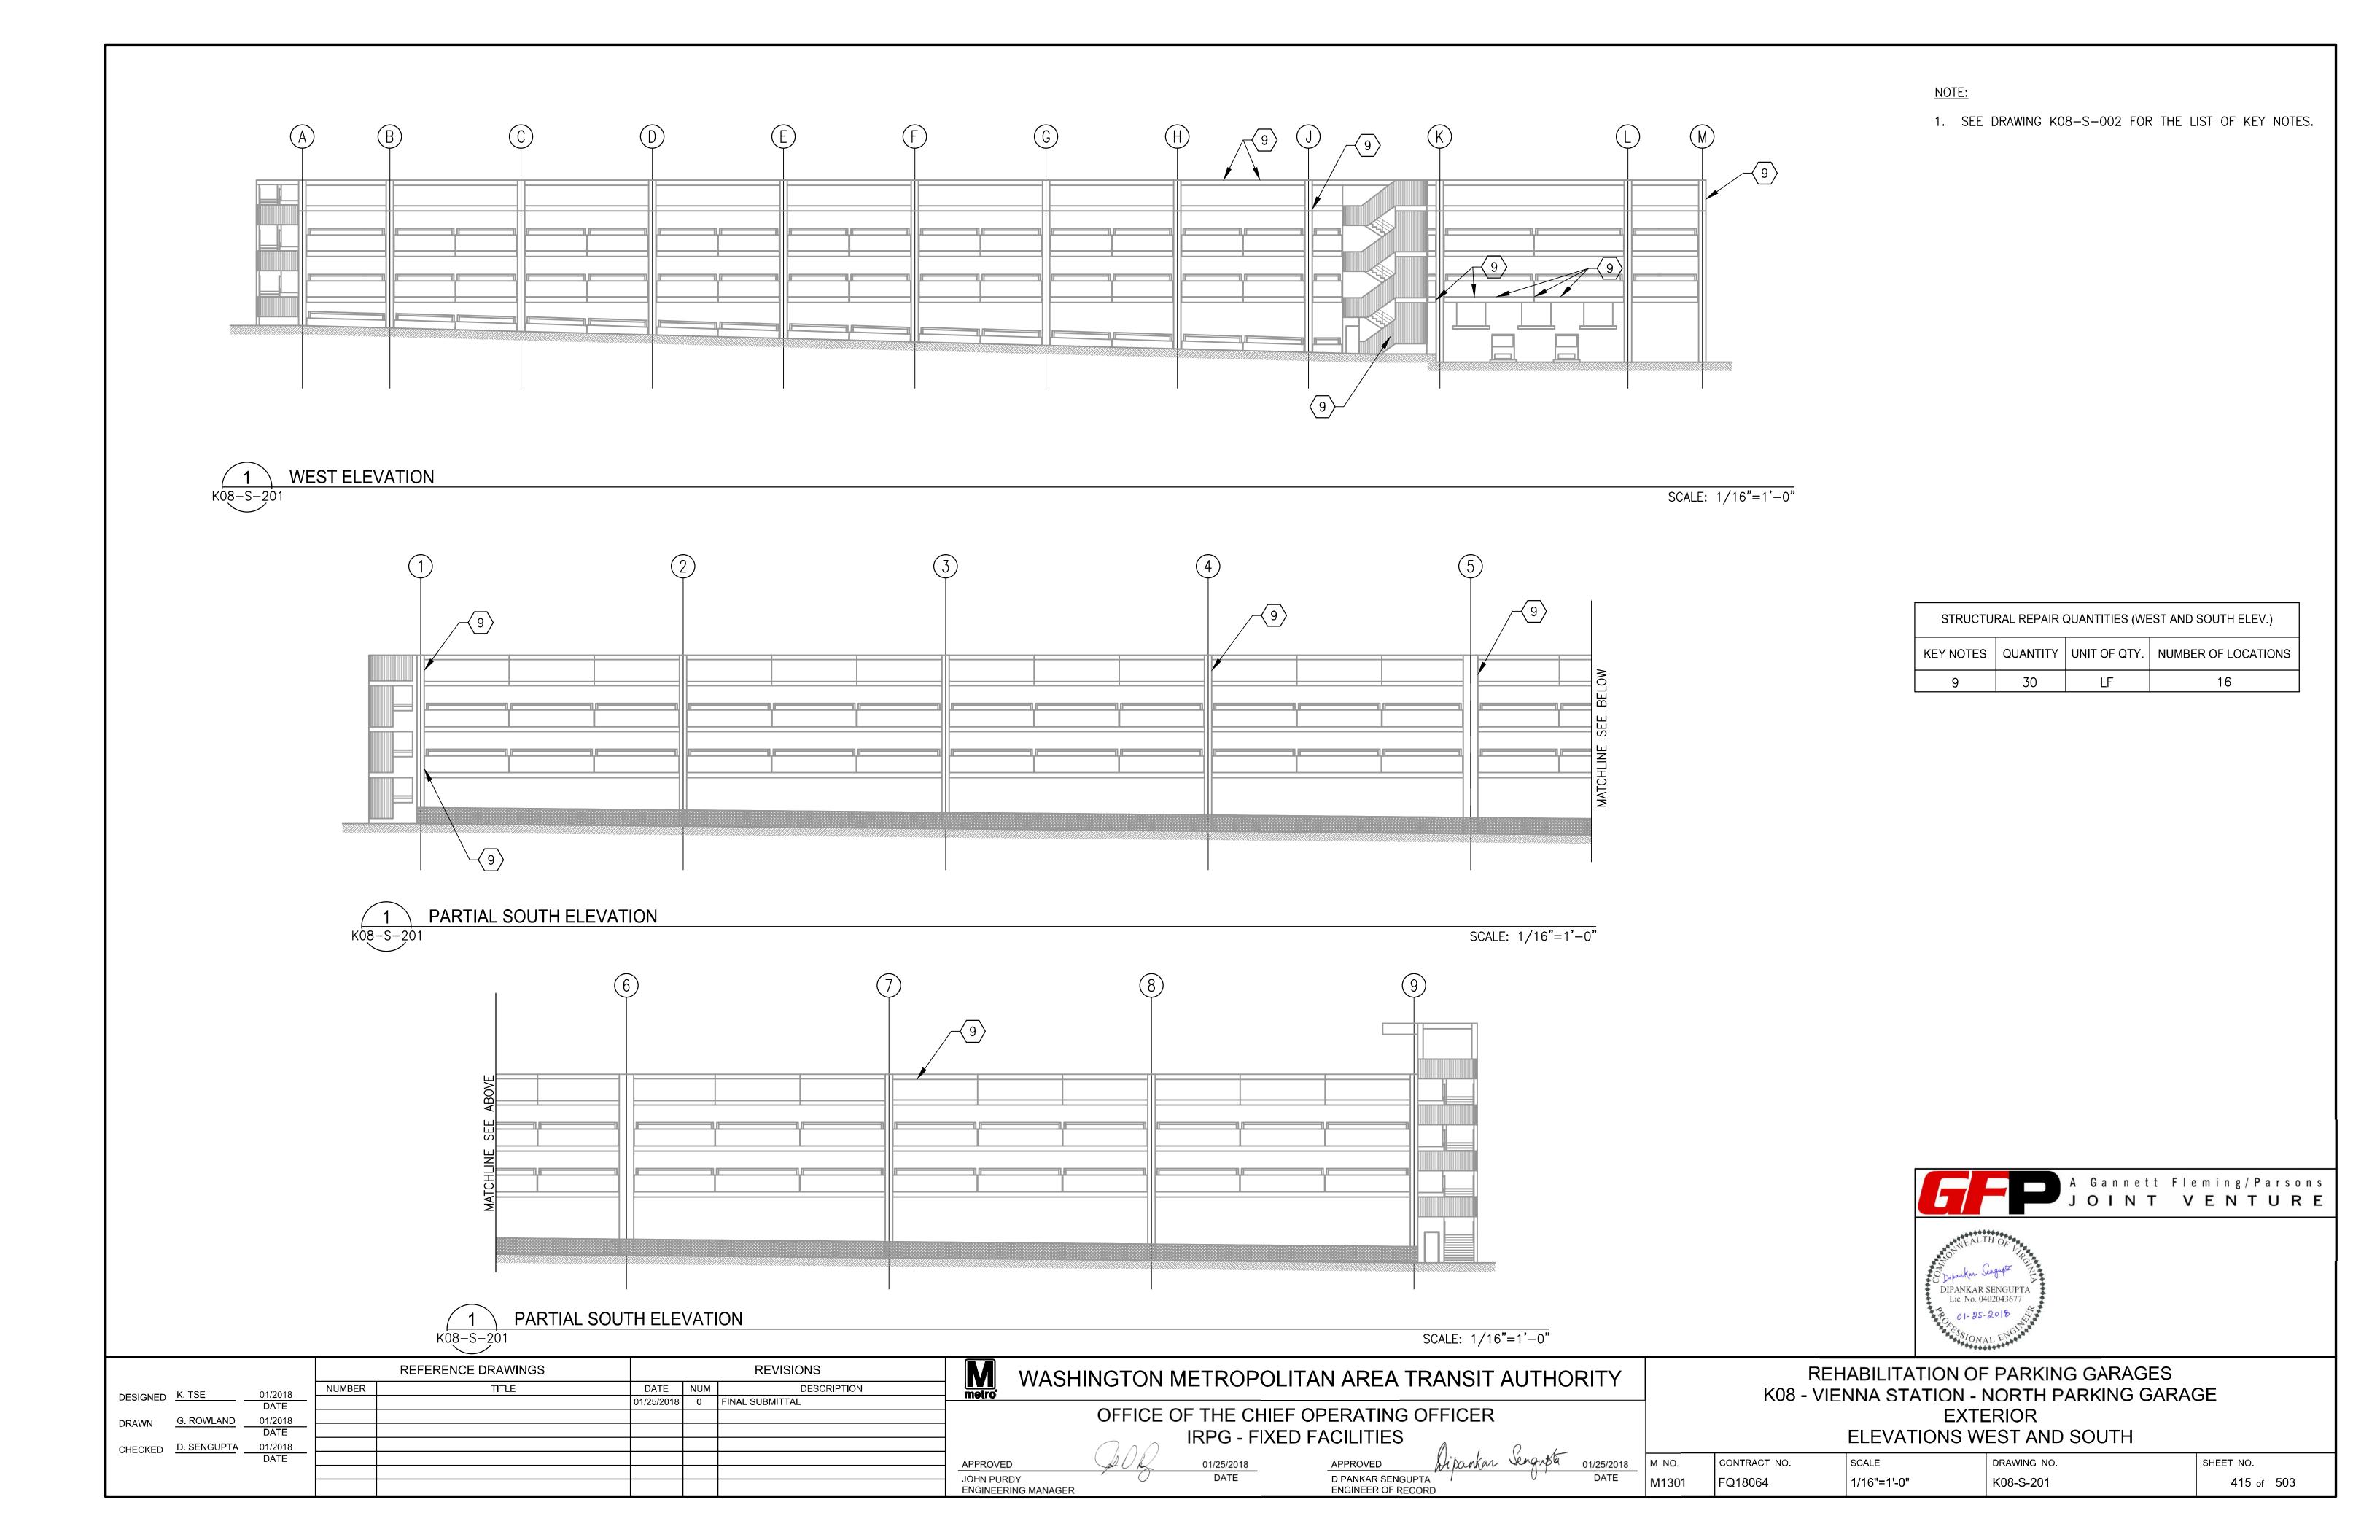


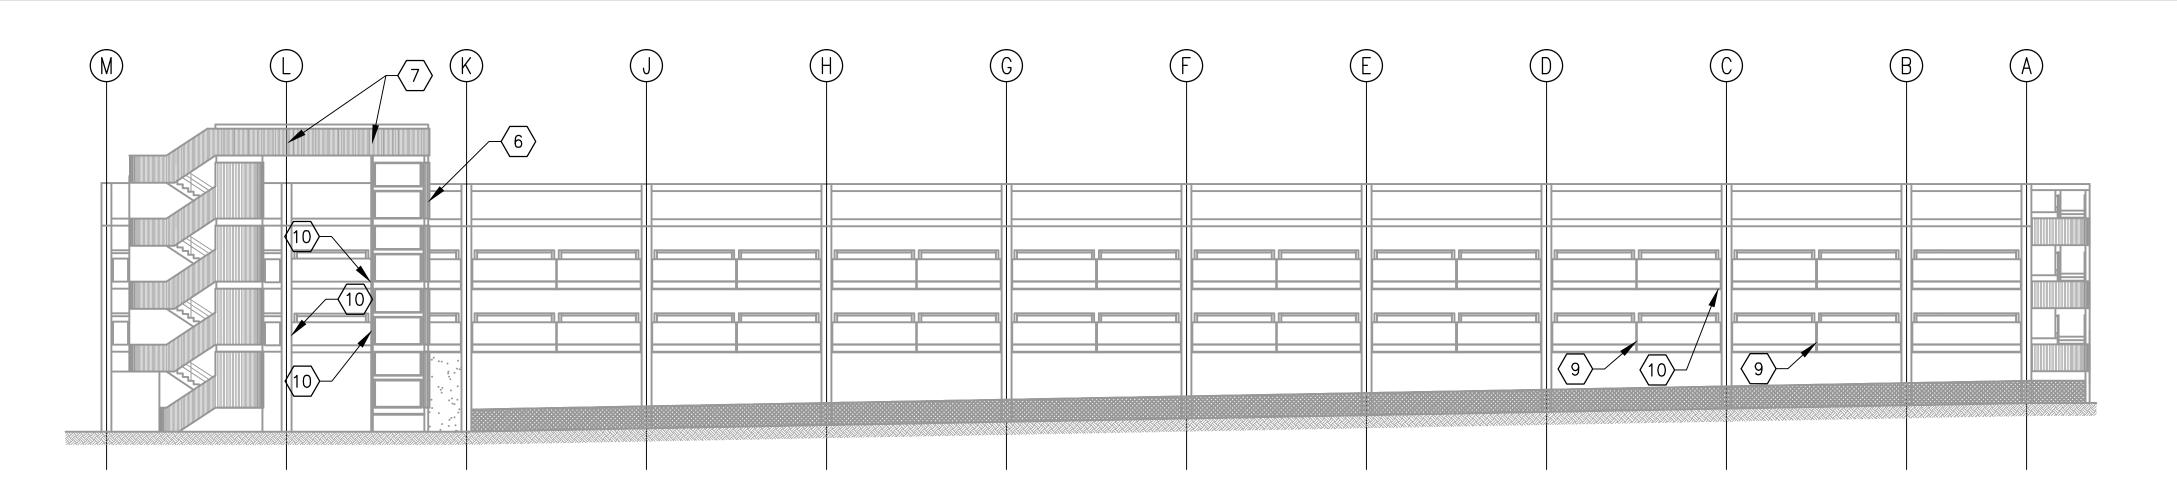

1 EAST ELEVATION

K08-S-202

SCALE: 1/16"=1'-0"

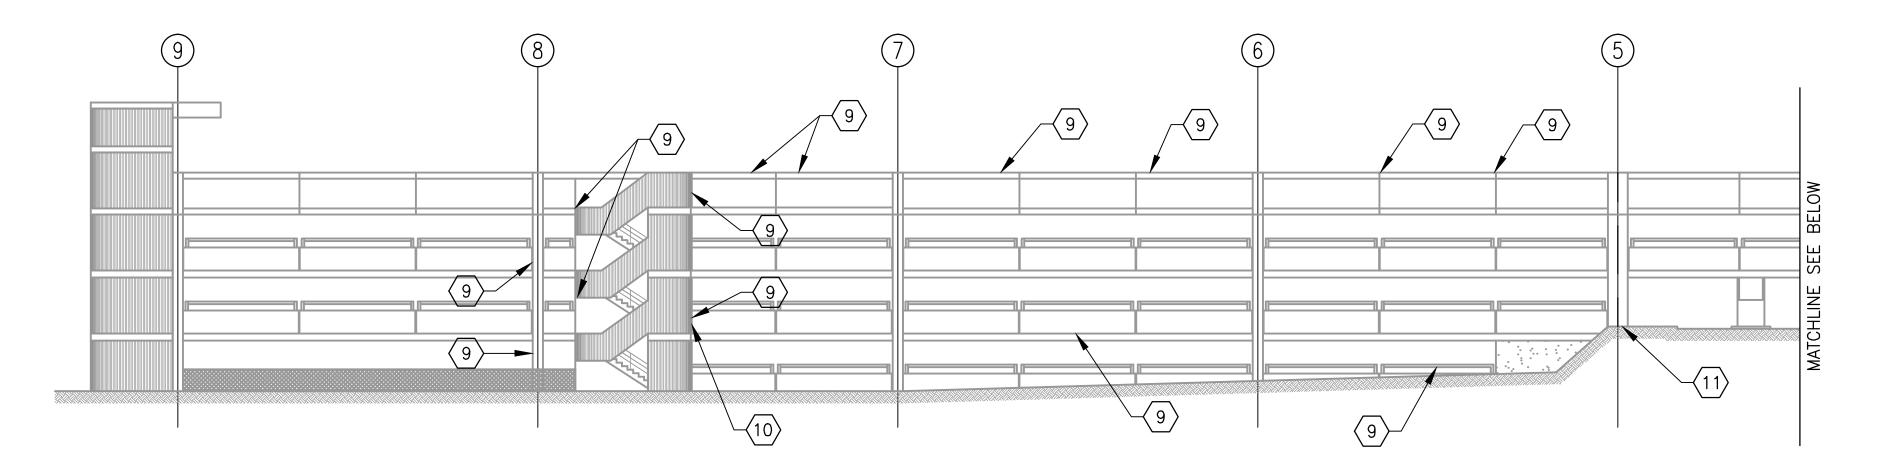


STRUCTURAL REPAIR QUANTITIES (EAST AND NORTH ELEV.)									
KEY NOTES	QUANTITY	UNIT OF QTY.	NUMBER OF LOCATIONS						
6 16 LF 1									
7	8	LF	4						
9	58	LF	38						
10	10								
11 2 SF 1									
11	18	SF SF	1						

1. SEE DRAWING K08-S-002 FOR THE LIST OF KEY NOTES.



SCALE: 1/16"=1'-0"

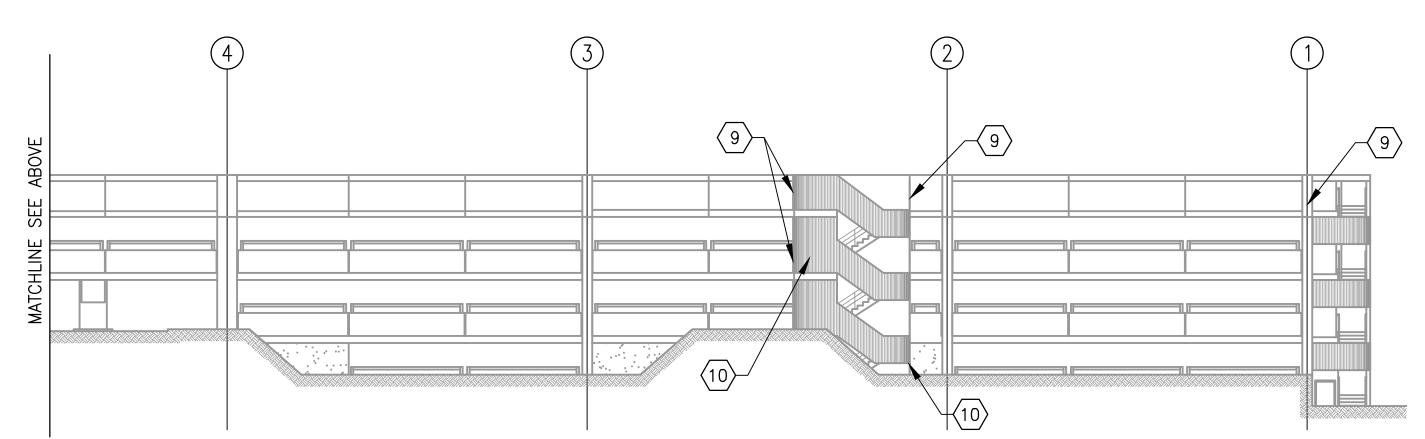

A Gannett Fleming/Parsons
JOINT VENTURE



NOTE:

ı		1		PARTIAL NORTH ELEVATION
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SCALE: 1/16"=1'-0"

			REFERENCE DRAWINGS		REVISIONS			M	WASHI
	K. TSE	01/2018	NUMBER	TITLE	DATE	NUM	DESCRIPTION	metro	
DESIGNED	K. ISL	DATE			01/25/2018	0	FINAL SUBMITTAL	meno	
DRAWN	G. ROWLAND	01/2018							
DIVAVIII		DATE							
CHECKED	D. SENGUPTA	01/2018							
		DATE						APPROVE	D
								JOHN PUR	
									RING MANAGER


WASHINGTON METROPOLITAN AREA TRANSIT AUTHORITY OFFICE OF THE CHIEF OPERATING OFFICER IRPG - FIXED FACILITIES

CHEANNEAR CASONSPILA ENGINEER OF RECORD

01/25/2018 DATE


REHABILITATION OF PARKING GARAGES
K08 - VIENNA STATION - NORTH PARKING GARAGE
EXTERIOR
ELEVATIONS EAST AND NORTH


			ELEVATIONS EA	AST AND NORTH	
018	M NO.	CONTRACT NO.	SCALE	DRAWING NO.	SHEET NO.
	M1301	FQ18064	1/16"=1'-0"	K08-S-202	416 of 503

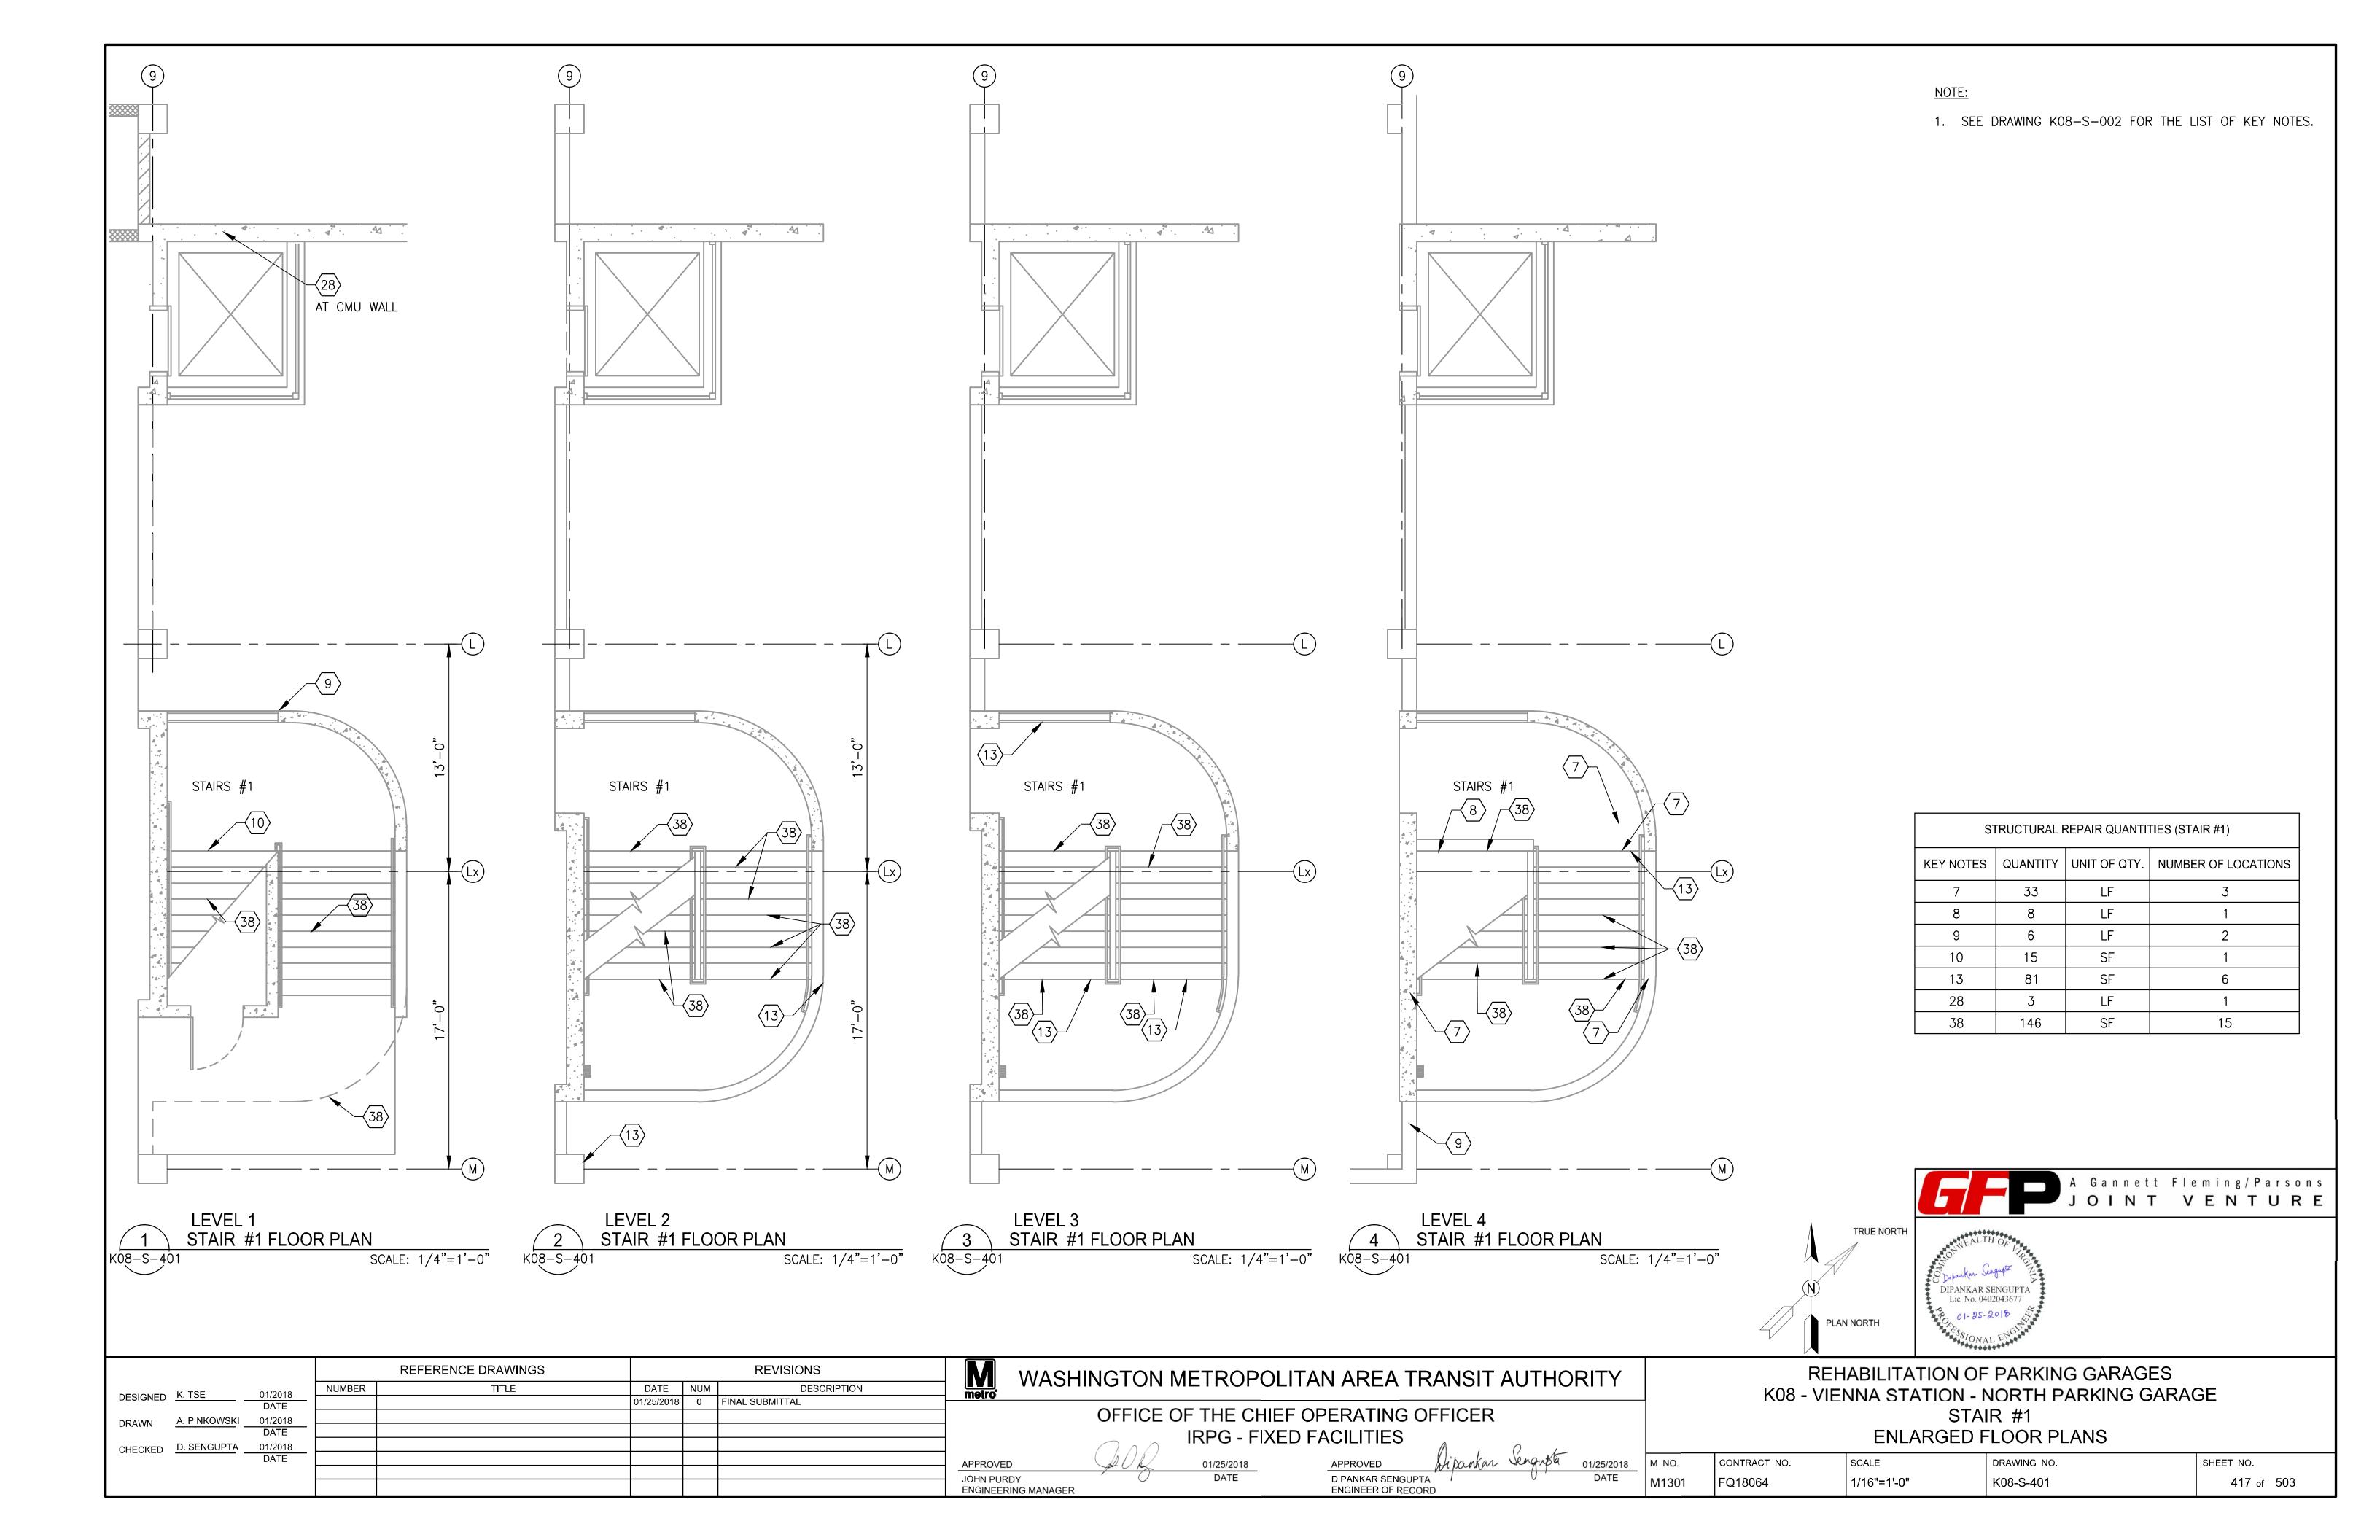



1. SEE DRAWING K08-S-002 FOR THE LIST OF KEY NOTES.

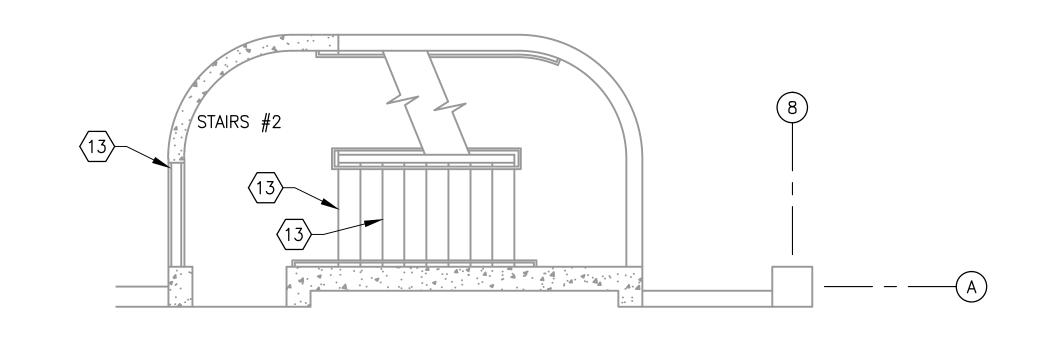

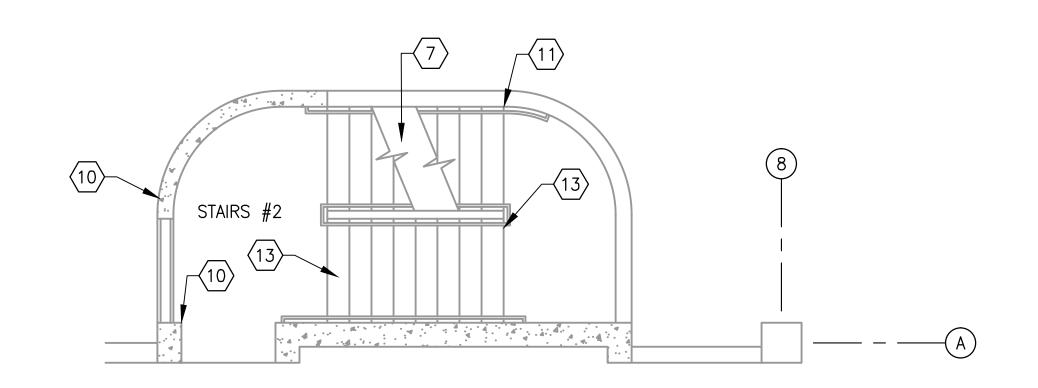


LEVEL 2 STAIR #2 FLOOR PLAN

SCALE: 1/4"=1'-0"


LEVEL 3 STAIR #2 FLOOR PLAN


SCALE: 1/4"=1'-0"

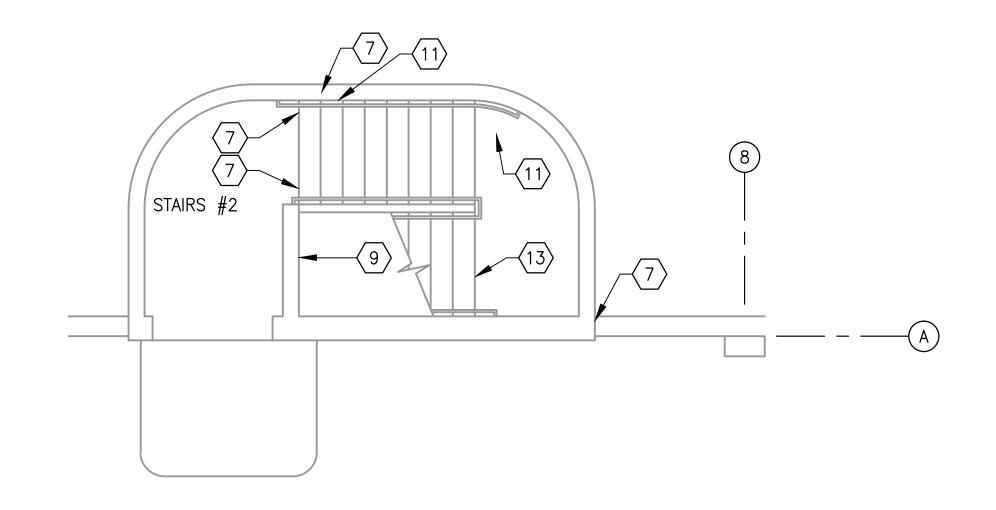

LEVEL 4 STAIR #2 FLOOR PLAN SCALE: 1/4"=1'-0"

	STRUCTURAL REPAIR QUANTITIES (STAIR #2)							
	KEY NOTES QUANTITY UNIT OF QTY. NUMBER OF LOCATIONS							
	7	66	LF	5				
	9	7	LF	1				
	10	3	SF	2				
11 8 SF 3								
	13	20	SF	7				

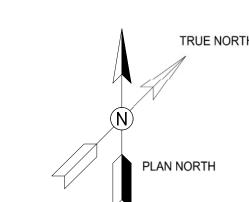

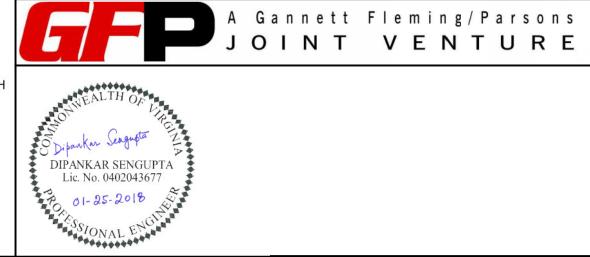

			REFERENCE DRAWINGS		REVISIONS				WASHI
DECIONED	K. TSE	01/2018	NUMBER	TITLE	DATE	NUM	DESCRIPTION	metro	VVASIII
DESIGNED	K. ISL	DATE			01/25/2018	0	FINAL SUBMITTAL	IIIGUO	
DRAWN	G. ROWLAND	01/2018						_	
		DATE							
CHECKED	D. SENGUPTA	01/2018							
		DATE						APPROV	ED
								JOHN PU	
									ERING MANAGER

WASHINGTON METROPOLITAN AREA TRANSIT AUTHORITY OFFICE OF THE CHIEF OPERATING OFFICER IRPG - FIXED FACILITIES 01/25/2018

DIPANKAR SENGUPTA ENGINEER OF RECORD

DRAWING NO. CONTRACT NO. SCALE


STAIR #2 ENLARGED FLOOR PLANS SHEET NO. FQ18064 K08-S-402 1/4"=1'-0" 418 of 503

REHABILITATION OF PARKING GARAGES

K08 - VIENNA STATION - NORTH PARKING GARAGE




1. SEE DRAWING K08-S-002 FOR THE LIST OF KEY NOTES.

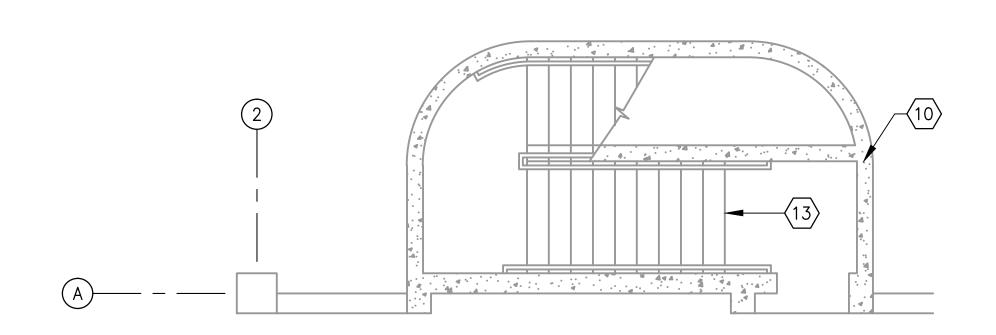




SCALE: 1/4"=1'-0"

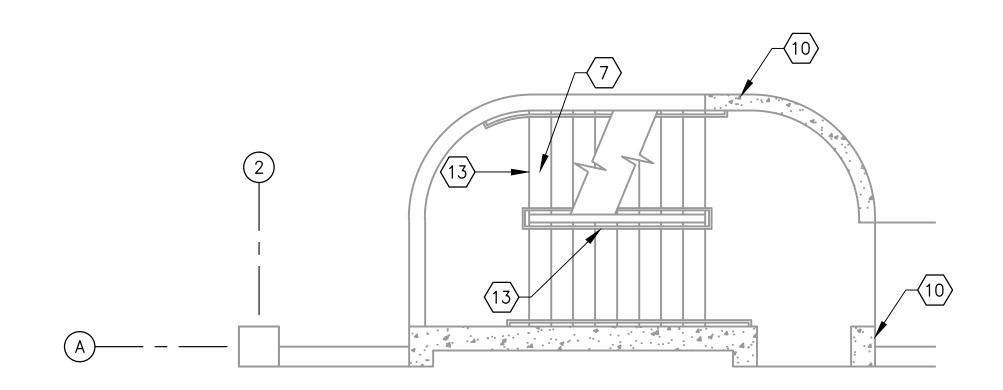




SCALE: 1/4"=1'-0"

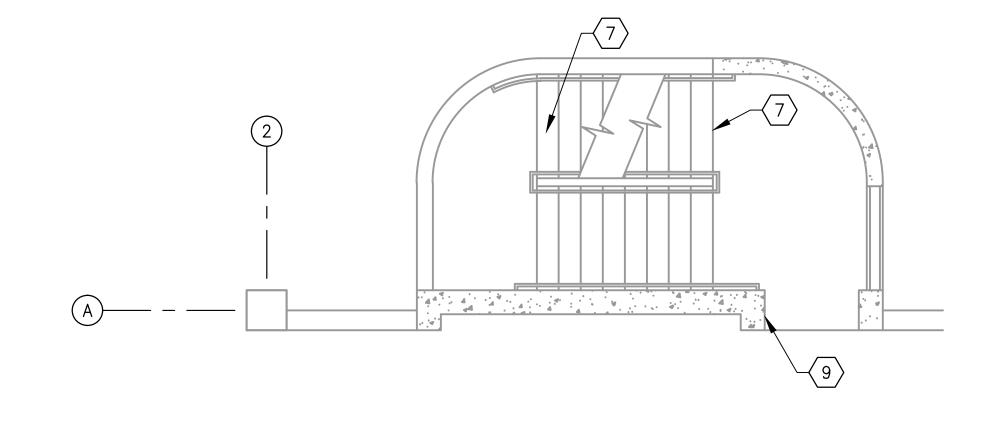




SCALE: 1/4"=1'-0"

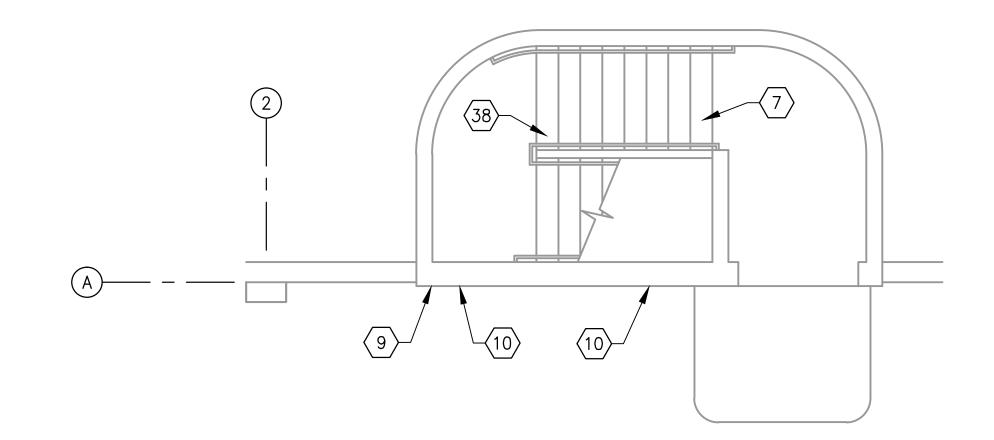

	LEVEL	_ 4		
(4)	STAIR	#3	FLOOR	PLAN
K08-S-403				

STRUCTURAL REPAIR QUANTITIES (STAIR #3)								
KEY NOTES QUANTITY UNIT OF QTY. NUMBER OF LOCATION								
7	28	LF	4					
9	3	LF	2					
10	9	SF	5					
13	29	SF	3					
38	3	SF	1					



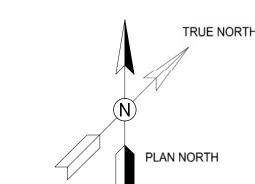

SCALE: 1/4"=1'-0"

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	5 Dipankar Sengupta Z
	DIPANKAR SENGUPTA
	Lic. No. 0402043677
	01-25-2018 5
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	PARAMA

				REFERENCE DRAWINGS			REVISIONS	M	WASHIN
DECLONED	K. TSE	01/2018	NUMBER	TITLE	DATE	NUM	DESCRIPTION	metro:	
DESIGNED	K. IOL	DATE			01/25/2018	0	FINAL SUBMITTAL	IIIGUO	
DRAWN	G. ROWLAND	01/2018							
		DATE							
CHECKED	D. SENGUPTA	01/2018							
		DATE						APPROVE	D
								JOHN PUF	RDY
								ENGINEE	RING MANAGER

	Metro*	WASH	INGTON	METROP	OLITAI	N AREA TF	RANSIT	AUTHO	RITY	
			OFFICE (· · · · · · · · · · · · · · · · · · ·		ERATING C	FFICER			
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┨	APPROVED)	JUR V	01/25/2018		APPROVED	Stipankar	Jeograpa	01/25/2018	V
	JOHN PURI ENGINEER	OY NG MANAGER	, 0	DATE		DIPANKAR SENGUPTA		0 '	DATE	١

01/25/2018	M NO.	CONTRACT
DATE	M1301	FQ18064

REHABILITATION OF PARKING GARAGES
K08 - VIENNA STATION - NORTH PARKING GARAG
STAIR #3
ENLARGED FLOOR PLANS

	ENLARGED FLOOR PLANS				
18	M NO.	CONTRACT NO.	SCALE	DRAWING NO.	SHEET NO.
	M1301	FQ18064	1/4"=1'-0"	K08-S-403	419 of 503